





1 FIRST FLOOR ELECTRICAL PLAN
E-2 SCALE: 1/4" = 1'-0"

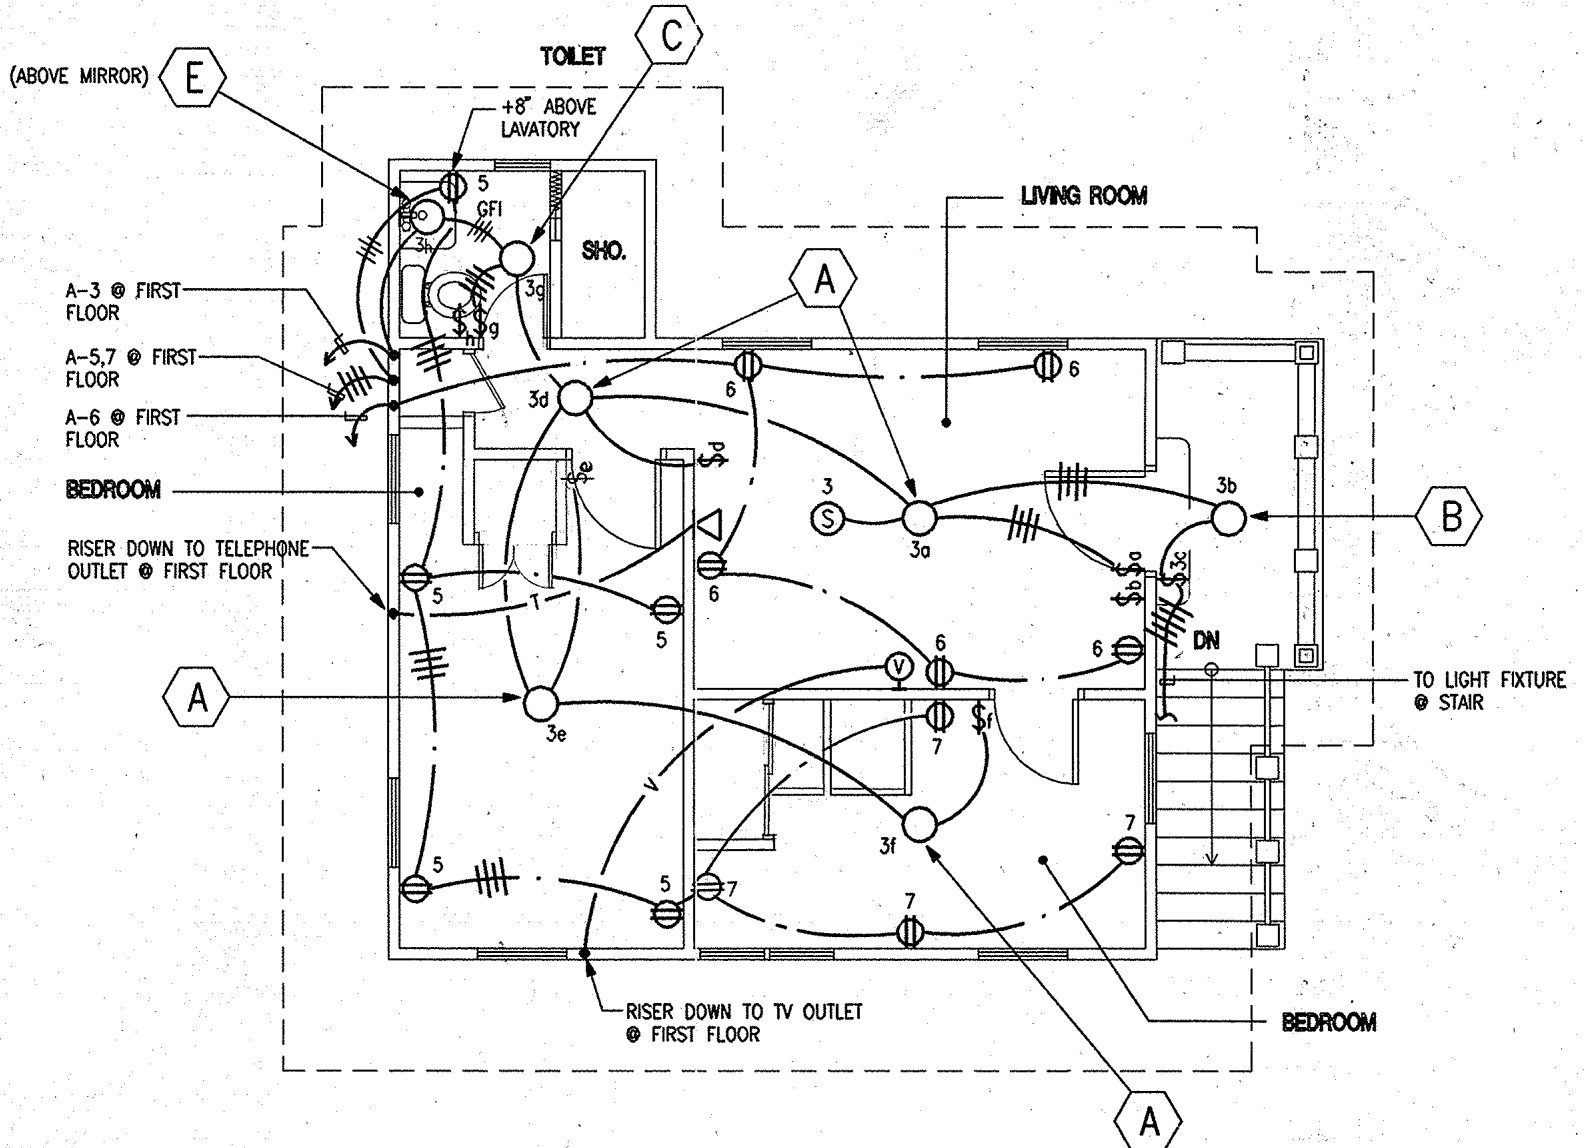

2 SECOND FLOOR ELECTRICAL PLAN
E-2 SCALE: 1/4" = 1'-0"

- MOUNTING : CEILING, SURFACE
- LAMP : INCANDESCENT, 2-60 WATT
- DIFFUSER : FROSTED GLASS, WEATHER RESISTANT AND SHATTERPROOF POLYPROPYLENE
- VOLT : 120 VOLT


TYPE "A"

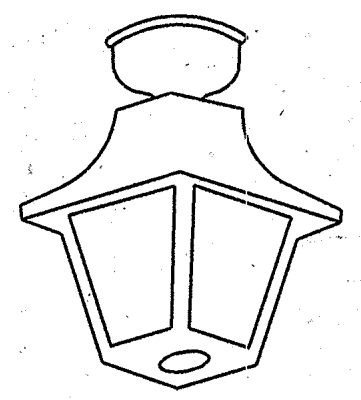


- MOUNTING : CEILING, SURFACE
- LAMP : INCANDESCENT, 1-100 WATT
- DIFFUSER : CLEAR HAMMERED ACRYLIC, WEATHER RESISTANT AND SHATTERPROOF POLYPROPYLENE
- VOLT : 120 VOLT

TYPE "B"

3 LIGHTING FIXTURE SCHEDULE
E-2 NOT TO SCALE

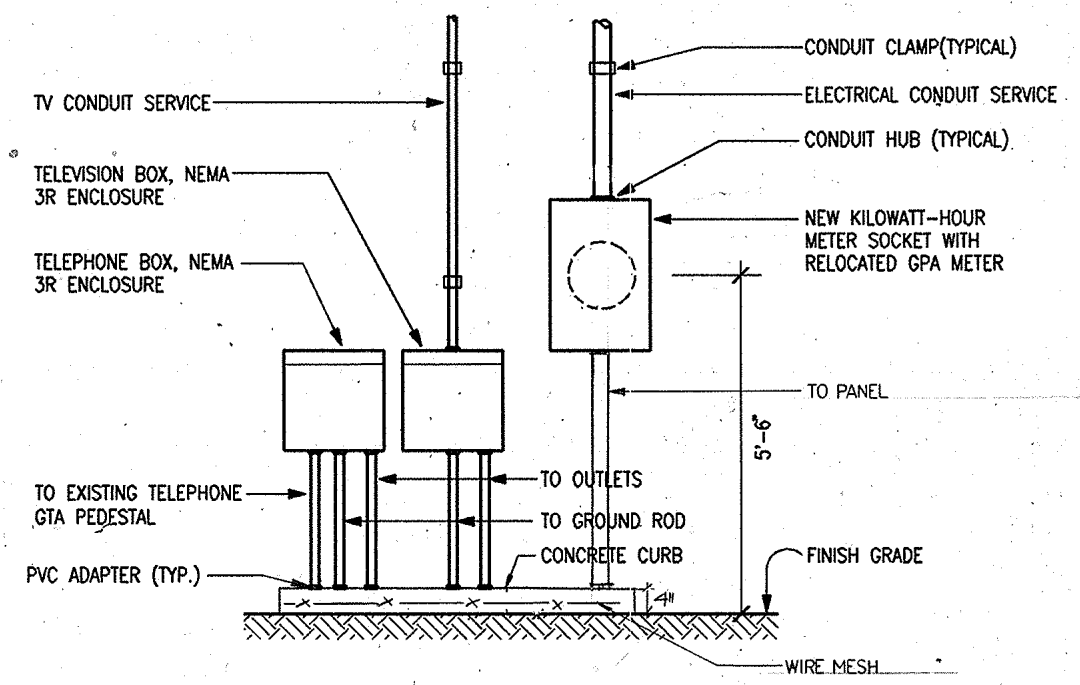


4 ELEVATION
E-2 NOT TO SCALE

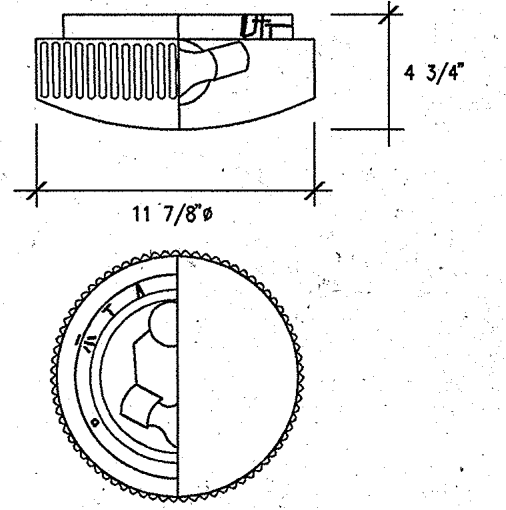


- MOUNTING : CEILING, SURFACE MOUNTED
- LAMP : INCANDESCENT, 2-60 WATT
- DIFFUSER : HINGED SATIN FINISHED GLASS WITH FLUTED EDGED. DIECAST ALUMINUM CANOPY, MATTE WHITE FINISHED. SUITABLE FOR DAMP LOCATION
- VOLT : 120 VOLT

TYPE "C"

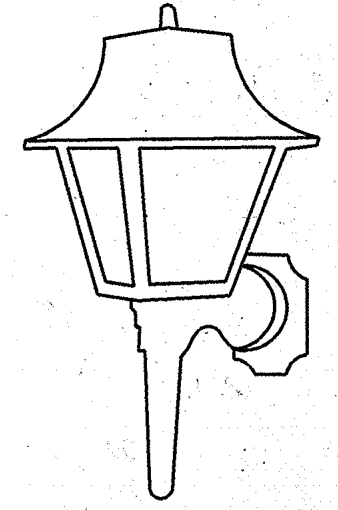

- MOUNTING : WALL, SURFACE
- LAMP : INCANDESCENT, 1-100 WATT
- DIFFUSER : CLEAR HAMMERED ACRYLIC, WEATHER RESISTANT AND SHATTERPROOF POLYPROPYLENE
- VOLT : 120 VOLT

TYPE "D"

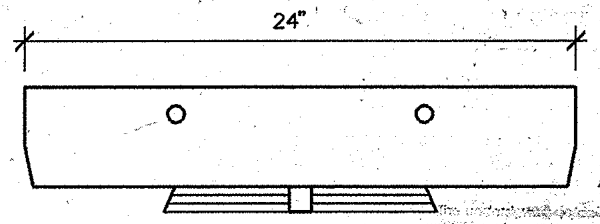

- MOUNTING : WALL, SURFACE
- LAMP : INCANDESCENT, 2-75 WATT
- VOLT : 120 VOLT

TYPE "E"

ME ENGINEERS, INC.
CONSULTING ENGINEERS
1105 2ND FLOOR BUILDING, TAMUNING, GUAM
TEL: 466-5701 FAX: 466-9442 P.O. BOX 9463 TAMUNING, GUAM 96911

PROFESSIONAL ENGINEER
NO. 536
TERRITORY OF GUAM
12/2/92

I HEREBY CERTIFY THAT THIS PLAN WAS PREPARED BY ME OR UNDER MY DIRECT SUPERVISION.

REVISION	DATE	BY	DESCRIPTION	APPROVED
PROJECT NO.				
CONTRACT NO. PTA-033				
DESIGNED BY: EC				
DRAWN BY: EPSJR				
CHECKED BY: JE				
SUPV. BY: ES				
RECOMMENDED APPROVAL				DATE:
GUAM PRESERVATION TRUST				DATE:
SHEET CONTENT				
FIRST AND SECOND FLOOR ELECTRICAL PLAN, LIGHTING FIXTURE SCHEDULE AND ELEVATION (MENO HOUSE)				
DRAWER NO:				
willy a. watson, aia architect				DRAWING NUMBER E-2
				SHEET 14 OF 14

PROPOSED:


RESTORATION TO THE EXISTING HISTORICAL BUILDING

OWNER: MENO LOT NO. 67 INARAJAN, GUAM

SITE PLAN	LOCATION MAP	ABBREVIATIONS	INDEX OF DRAWINGS																																																																																																																																																																																																																																														
<p>Scale: 1" = 10'-0"</p>		<table border="0"> <tr> <td>ALUM.</td><td>AIR CONDITIONING</td><td>GRM</td><td>GRANITIZED</td></tr> <tr> <td>APPROX.</td><td>ALUMINUM</td><td>LAV.</td><td>LAVATORY</td></tr> <tr> <td>ARCH.</td><td>APPROXIMATE</td><td>MACB.</td><td>MACROBOLT</td></tr> <tr> <td>AC.</td><td>ARCHITECTURAL</td><td>MAN.</td><td>MANHOLE</td></tr> <tr> <td>BM.</td><td>ASPHALTIC CEMENT</td><td>MANUF.</td><td>MANUFACTURER</td></tr> <tr> <td>BET.</td><td>BEAM</td><td>MO</td><td>MASONRY OPENING</td></tr> <tr> <td>BD</td><td>BETWEEN</td><td>MATL.</td><td>MATERIALS</td></tr> <tr> <td>BOL.</td><td>BOARD</td><td>MAX.</td><td>MAXIMUM</td></tr> <tr> <td>BULDG.</td><td>BOTTOM</td><td>MECH.</td><td>MECHANICAL</td></tr> <tr> <td>CAB.</td><td>BUILDING</td><td>MIN.</td><td>MINIMUM</td></tr> <tr> <td>CAF.</td><td>CABINET</td><td>MIS.</td><td>MISCELLANEOUS</td></tr> <tr> <td>CLG.</td><td>CAST-IN-PLACE CONCRETE</td><td>NDS</td><td>NOT TO SCALE</td></tr> <tr> <td>CEM.</td><td>CEILING</td><td>OC</td><td>ON CENTER</td></tr> <tr> <td>CLR.</td><td>CERAMIC TILE</td><td>OPNG.</td><td>OPENING</td></tr> <tr> <td>COL.</td><td>CLEARANCE</td><td>ODI</td><td>OUTSIDE DIAMETER</td></tr> <tr> <td>COMP.</td><td>COLUMN</td><td>OFI</td><td>OWNER FURNISHED CONTRACTOR INSTALLED</td></tr> <tr> <td>CONC.</td><td>COMPACTED CONCRETE</td><td>PTD</td><td>PAPER TOWEL DISPENSER</td></tr> <tr> <td>CONC.</td><td>CONCRETE MASONRY UNIT</td><td>PLAS.</td><td>PLASTER</td></tr> <tr> <td>CONSTR.</td><td>CONNECTION</td><td>PLYWD.</td><td>PLYWOOD</td></tr> <tr> <td>CONT.</td><td>CONTINUOUS OR CONTINUE</td><td>PVC</td><td>POLYVINYL CHLORIDE</td></tr> <tr> <td>CORR.</td><td>CORRUGATED</td><td>PC</td><td>PRECAST CONCRETE</td></tr> <tr> <td>DEP.</td><td>DEPRESSED</td><td>PL</td><td>PROPERTY LINE</td></tr> <tr> <td>DET.</td><td>DETAIL</td><td>QUART.</td><td>QUARRY TILE</td></tr> <tr> <td>DIA.</td><td>DIAMETER</td><td>RAD</td><td>RADIUS</td></tr> <tr> <td>DIM.</td><td>DIMENSION</td><td>REIN.</td><td>REINFORCED OR REINFORCING</td></tr> <tr> <td>DS.</td><td>DOWNSPOUT</td><td>RM</td><td>ROOM</td></tr> <tr> <td>DWG.</td><td>DRAWING</td><td>RO</td><td>ROUGH OPENING</td></tr> <tr> <td>DF.</td><td>DRINKING FOUNTAIN</td><td>SCHED.</td><td>SCHEDULE</td></tr> <tr> <td>EF.</td><td>EACH FACE</td><td>SEC</td><td>SECTION</td></tr> <tr> <td>EW.</td><td>ELECTRICAL</td><td>SEK</td><td>SEWER SINK OR STAINLESS STEEL</td></tr> <tr> <td>EW/C.</td><td>ELECTRIC WATER COOLER</td><td>SHT</td><td>SHEET</td></tr> <tr> <td>EL/ELEV.</td><td>ELEVATION</td><td>SIM.</td><td>SIMILAR</td></tr> <tr> <td>EQUIP.</td><td>EQUIPMENT</td><td>SOL.</td><td>SOLID CORE</td></tr> <tr> <td>EXISTG.</td><td>EXISTING</td><td>SPC.</td><td>SPRINKLER</td></tr> <tr> <td>EXT.</td><td>EXTENSION</td><td>STD.</td><td>STANDARD</td></tr> <tr> <td>FIN.</td><td>FINISH</td><td>STL</td><td>STEEL</td></tr> <tr> <td>FR.</td><td>FIRE EXTINGUISHER</td><td>STR.</td><td>STRUT</td></tr> <tr> <td>FLR.</td><td>FLOOR OR FLOORING</td><td>STRUC.</td><td>STRUCTURE</td></tr> <tr> <td>FR.</td><td>FLOOR DRAIN</td><td>TEMP.</td><td>TEMPERED</td></tr> <tr> <td>FOVING.</td><td>FOOTING</td><td>THK.</td><td>THICK OR THICKNESS</td></tr> <tr> <td>FND.</td><td>FOUNDATION</td><td>TRK.</td><td>TRUCK</td></tr> <tr> <td>GYP.</td><td>GYP-SUM BOARD</td><td>TRP.</td><td>TRIP</td></tr> <tr> <td>HW.</td><td>HARDWARE</td><td>URINAL</td><td>URINAL</td></tr> <tr> <td>HW/D.</td><td>HARDWOOD</td><td>UR.</td><td>URINAL</td></tr> <tr> <td>HGT.</td><td>HEIGHT</td><td>VERT.</td><td>VERTICAL</td></tr> <tr> <td>HOL.</td><td>HOLLOW CORE</td><td>VAT</td><td>VINYL ASBESTOS TILE</td></tr> <tr> <td>HORIZ.</td><td>HORIZONTAL</td><td>WC</td><td>WATER CLOSURE</td></tr> <tr> <td>INT.</td><td>INTERIOR</td><td>WH</td><td>WATER HEATER</td></tr> <tr> <td>INT.</td><td>INTERIOR</td><td>W/M</td><td>WELDED WIRE MESH</td></tr> <tr> <td>INT.</td><td>INTERIOR</td><td>WOW</td><td>WINDOW</td></tr> <tr> <td>INT.</td><td>INTERIOR</td><td>WD</td><td>WOOD</td></tr> <tr> <td>KIT.</td><td>KITCHEN</td><td></td><td></td></tr> </table>	ALUM.	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A-6	DETAIL PLAN, SECTIONS OF 2ND FLOOR BATHROOM, WALL SECTIONS																																																																																																																																																																																																																																																
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A-8	DETAILS OF CABINETS, MISCELLANEOUS DETAILS																																																																																																																																																																																																																																																
S-1	FOUNDATION PLAN, FOOTING DETAILS, RATIO ROOF FRAMING PLAN AND DETAILS, DETAILS OF BEAMS																																																																																																																																																																																																																																																
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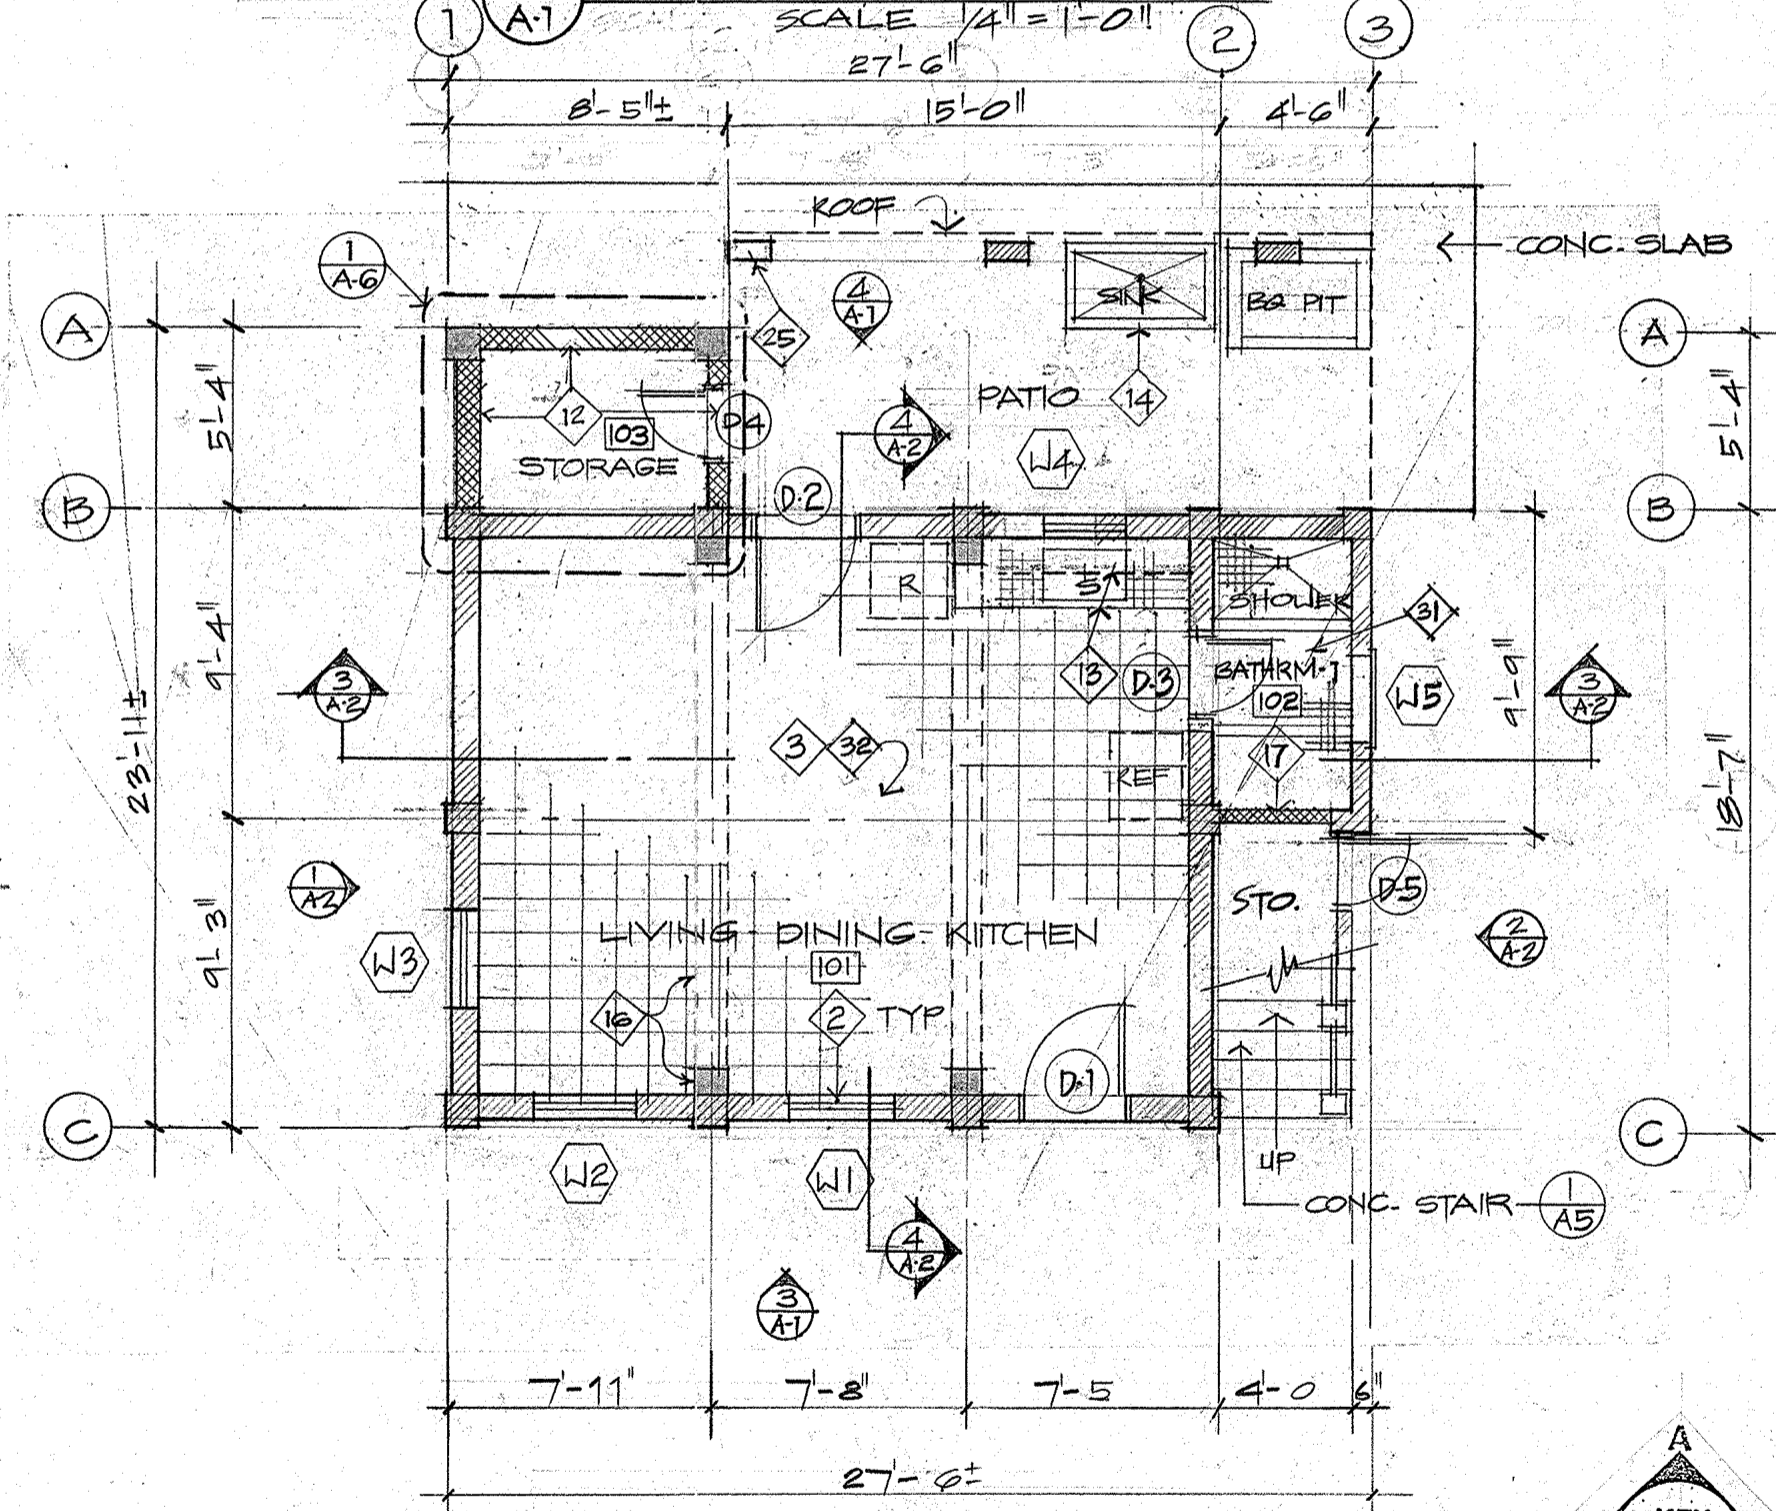
SCOPE OF WORK

- 1 REPLACE ALL EXISTING WOOD DOORS AND WOOD FRAMES. PROVIDE NEW HARDWARES.
- 2 REPLACE ALUMINUM OPERATORS and GLASS LOWER BLADES. INSTALL NEW INSECT SCREEN.
- 3 CLEAN CONCRETE FLOOR SLAB, ROUGHEN SURFACE and POUR NEW 3" THK. CONC. SLAB w/ WAF.
- 4 CLEAN CONC. WALLS, COLUMNS, BEAMS AND PATCH SPALLS AND CRACKS.
- 5 PROVIDE and INSTALL NEW 1" x 2" T & S WD. FLOOR, 2" x 6" FLOOR JOISTS and BRIDGING, 3" x 6" WD. LEDGER.
- 6 INSTALL NEW CEILING BOARDS and WOOD NAILERS. PROVIDE NEW GYPSUM CEILING.
- 7 INSTALL NEW 2" x 4" WD. STUDS ON EXTERIOR WALLS and PARTITIONS. PROVIDE 15-LB FELT SEPARATION FOR WOOD IN CONTACT WITH CONCRETE.
- 8 INSTALL NEW WD SIDINGS AS PROVIDED BY OPT OFFICER. RETRIEVE APPROX. 1000 LF OF SIDING IN STORAGE OFF SITE (MALO) AS DIRECTED BY OPT.
- 9 INSTALL NEW 22-GA CORR. GALV. TIN ROOFING, GUTTER and DOWNSPOUT. PROVIDE CONC. SPLASH BLOCKS.
- 10 INSTALL NEW WD ROOF FRAMING, BRACES and ANCHORS AS REQUIRED.
- 11 INSTALL NEW PATIO ROOF and WD FRAMING.
- 12 INSTALL NEW CMU WALL w/ CEMENT PLASTER FIN.
- 13 REMOVE & REPLACE KITCHEN BASE CABINET. INSTALL NEW WALL CABINET.
- 14 REPAIR CONCRETE SINK and BARBEQUE PIT. (N.I.C.)
- 15 INSTALL BEDROOM CLOSETS, SHELVES and LINEN CAB.
- 16 DEMOLISH EXISTING CONCRETE BEAMS and FOUR NEW CONCRETE BEAMS and COLUMN, and FOOTINGS.
- 17 INSTALL NEW 4" CMU WALL w/ CEMENT PLASTER FIN.
- 18 CLEAN and ROUGHEN DITCH ON STAIR TREADS and PATCH CONC. TO LEVEL w/ THE EXISTING.
- 19 REMOVE and REPLACE CONCRETE RAILING and POSTS FOUR NEW CONCRETE RAILING and POSTS AS DETAILED.
- 20 CLEAN SPALLS and CRACKS AT CONC. BALUSTERS and RAILINGS and PATCH w/ EPOXY GROUT.
- 21 INSTALL NEW WOOD BAND and FRAMES AS DETAILED.
- 22 POUR CONC. FLOOR SLAB and BEAMS (BATHROOM).
- 23 MODIFY WINDOW FRAME DETAIL TO MATCH EXIST. WOOD.
- 24 PLASTER WALL TO MAKE EVEN w/ THE EXISTING.
- 25 INSTALL ADDITIONAL 8" CMU COLUMN TO SUPPORT PATIO ROOF.
- 26 ADD NEW CONCRETE STEPS and SLAB.
- 27 PAINT EXTERIOR WALLS, INTERIOR WALLS, CEILING, CABINETS, ETC. AS SCHEDULED.
- 28 PROVIDE & INSTALL BLANKET TYPE INSULATION IN ROOF and ALL EXTERIOR WALLS. (N.I.C.)
- 29 INSTALL MED. CAB., TOILET PAPER HOLDER, TOWEL BAR, SHOWER CURTAIN ROD AT BATHROOMS.
- 30 REINSTALL OR PROVIDE NEW LAVATORY, WATER CLOSET, and WATER HEATER (OFC).
- 31 PROVIDE CER. TILE TILE WAINSCOTING and FLOORING FINISH AT THE BATHROOMS.
- 32 INSTALL VINYL TILE FLOOR and RUBBER COVE BASE AT THE GROUND FLOOR. (N.I.C.)

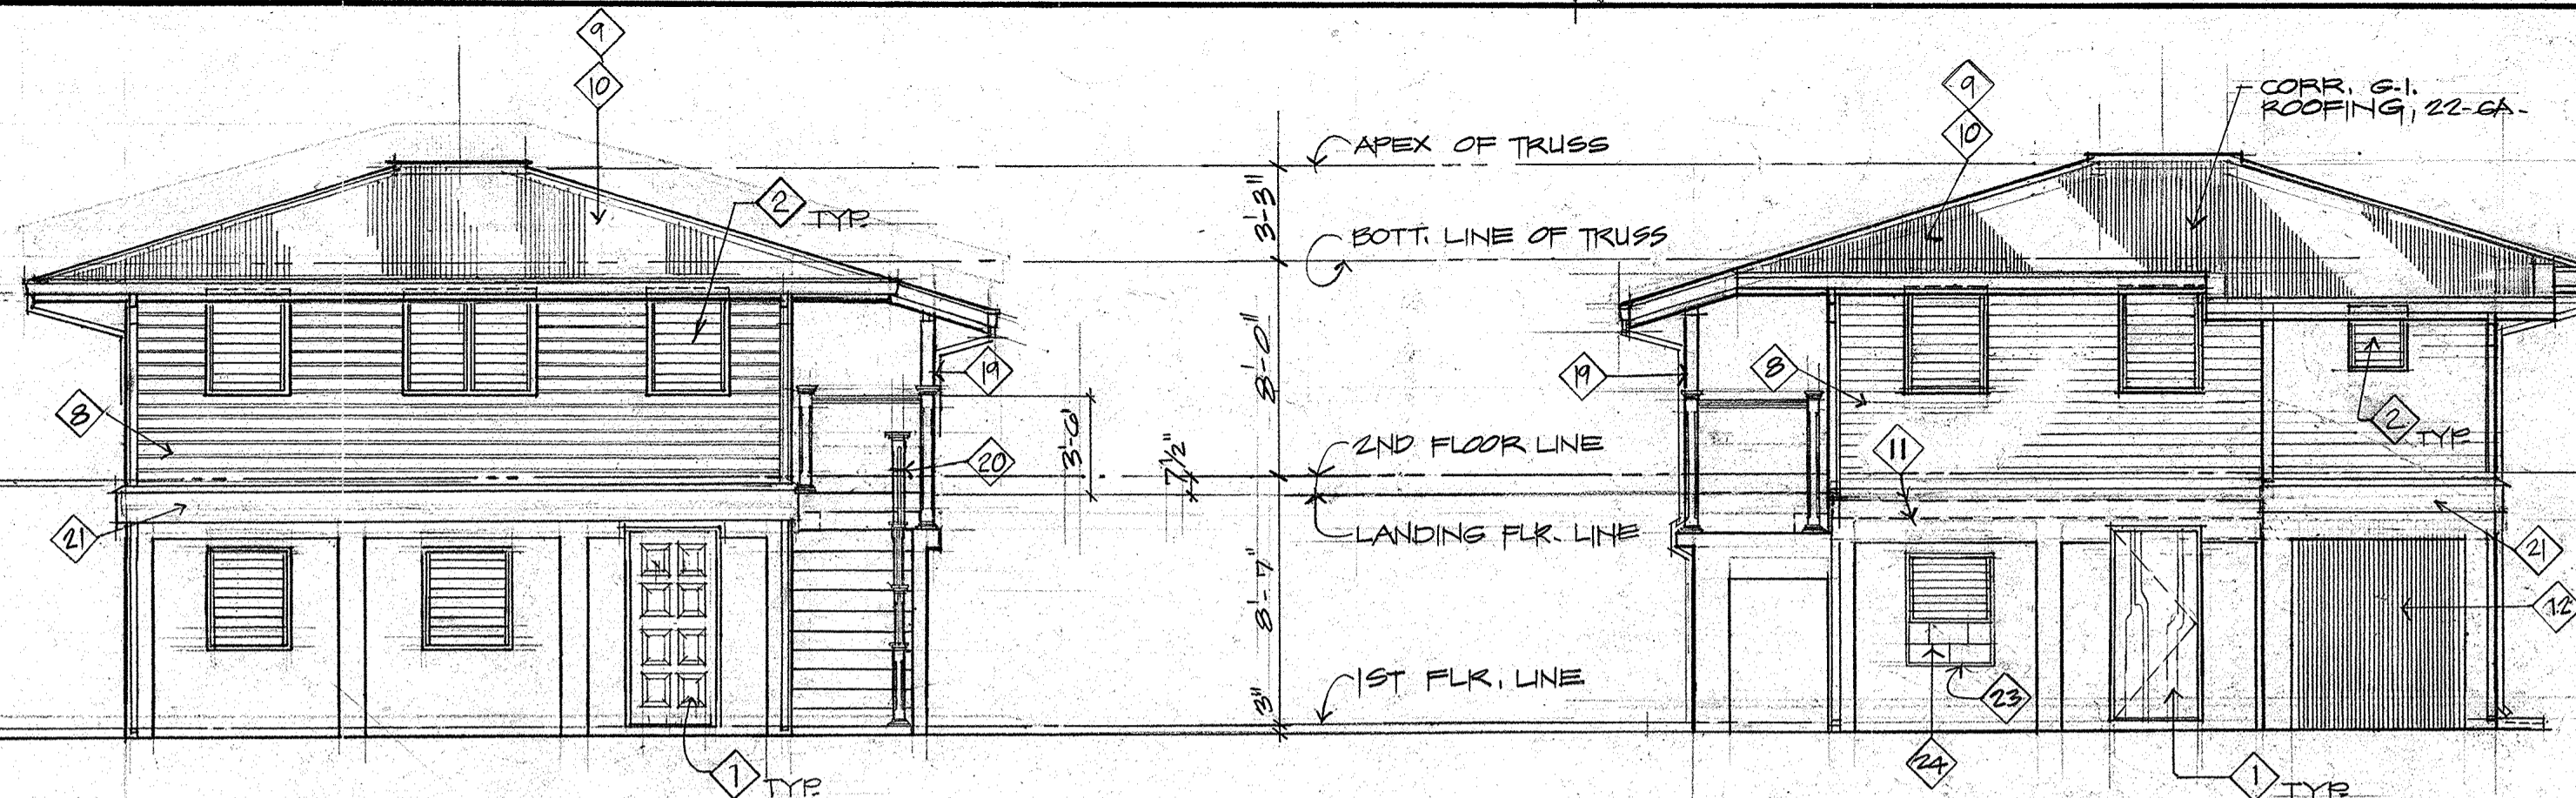


3 FRONT ELEVATION

4 REAR ELEVATION




1 1ST FLOOR PLAN

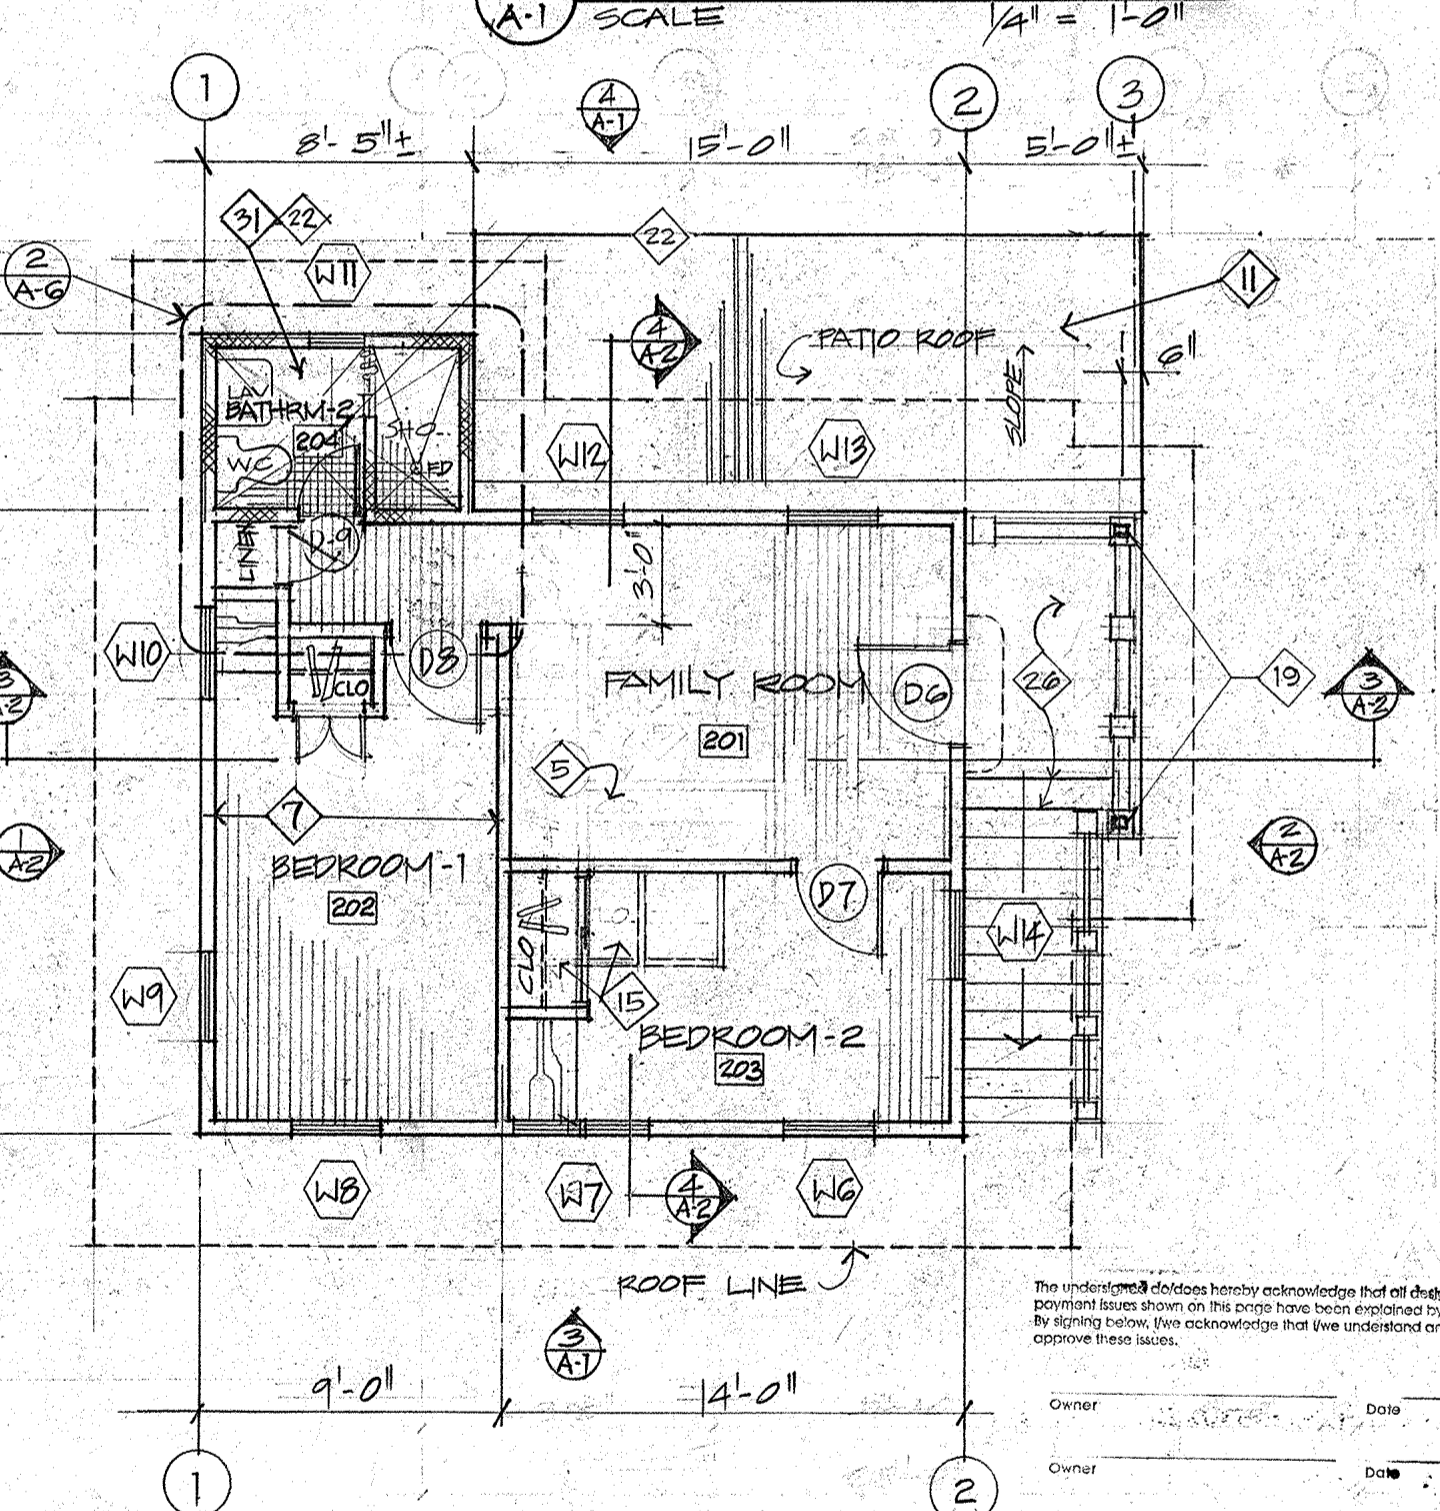


2 2ND FLOOR PLAN

NOTE:
DEMOLITION WORK ON SECOND FLOOR: WOOD FRAMINGS, WOOD FLOORINGS, INTERIOR and EXTERIOR WOOD WALLS, ROOF FRAMINGS and TIN ROOF HAS BEEN COMPLETED.


- 33 PROVIDE AND INSTALL LIGHT FIXTURES.
- 34 PROVIDE AND INSTALL PLUMBING AND ELECTRICAL ROUGH-INS.
- 35 INSTALL 1/4" THK CEMENTITIOUS BR SOFFIT AT ROOF OVERHUNG. (N.I.C.)
- 36 TERMITE CONTROL INTERIOR and EXTERIOR, 5'-0" OUT FROM BUILDING
- INDICATE AS BASE BID

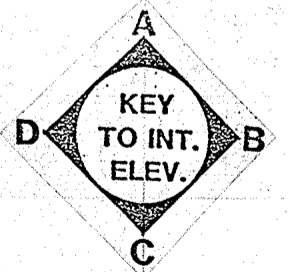

REVISION	DATE	BY	DESCRIPTION	APPROVED
PROJECT NO.				
CONTRACT NO. PTA-031				
DESIGNED BY: WAW			PROJECT: RESTORATION TO THE EXISTING HISTORICAL BUILDING	
DRAWN BY: ADS			MENO RESIDENCE	
CHECKED BY: WAW			LOT NO. 67 INARAJAN, GUAM	
SHEET CONTENTS 1ST AND 2ND FLOOR PLANS, FRONT AND REAR ELEVATIONS, SCOPE OF WORKS				
RECOMMENDED APPROVAL DATE:				
GUAM PRESERVATION TRUST DATE:				
willy a. watson, aia architect				
DRAWER NO. DRAWING NUMBER: A-1 SHEET 2 OF 14				

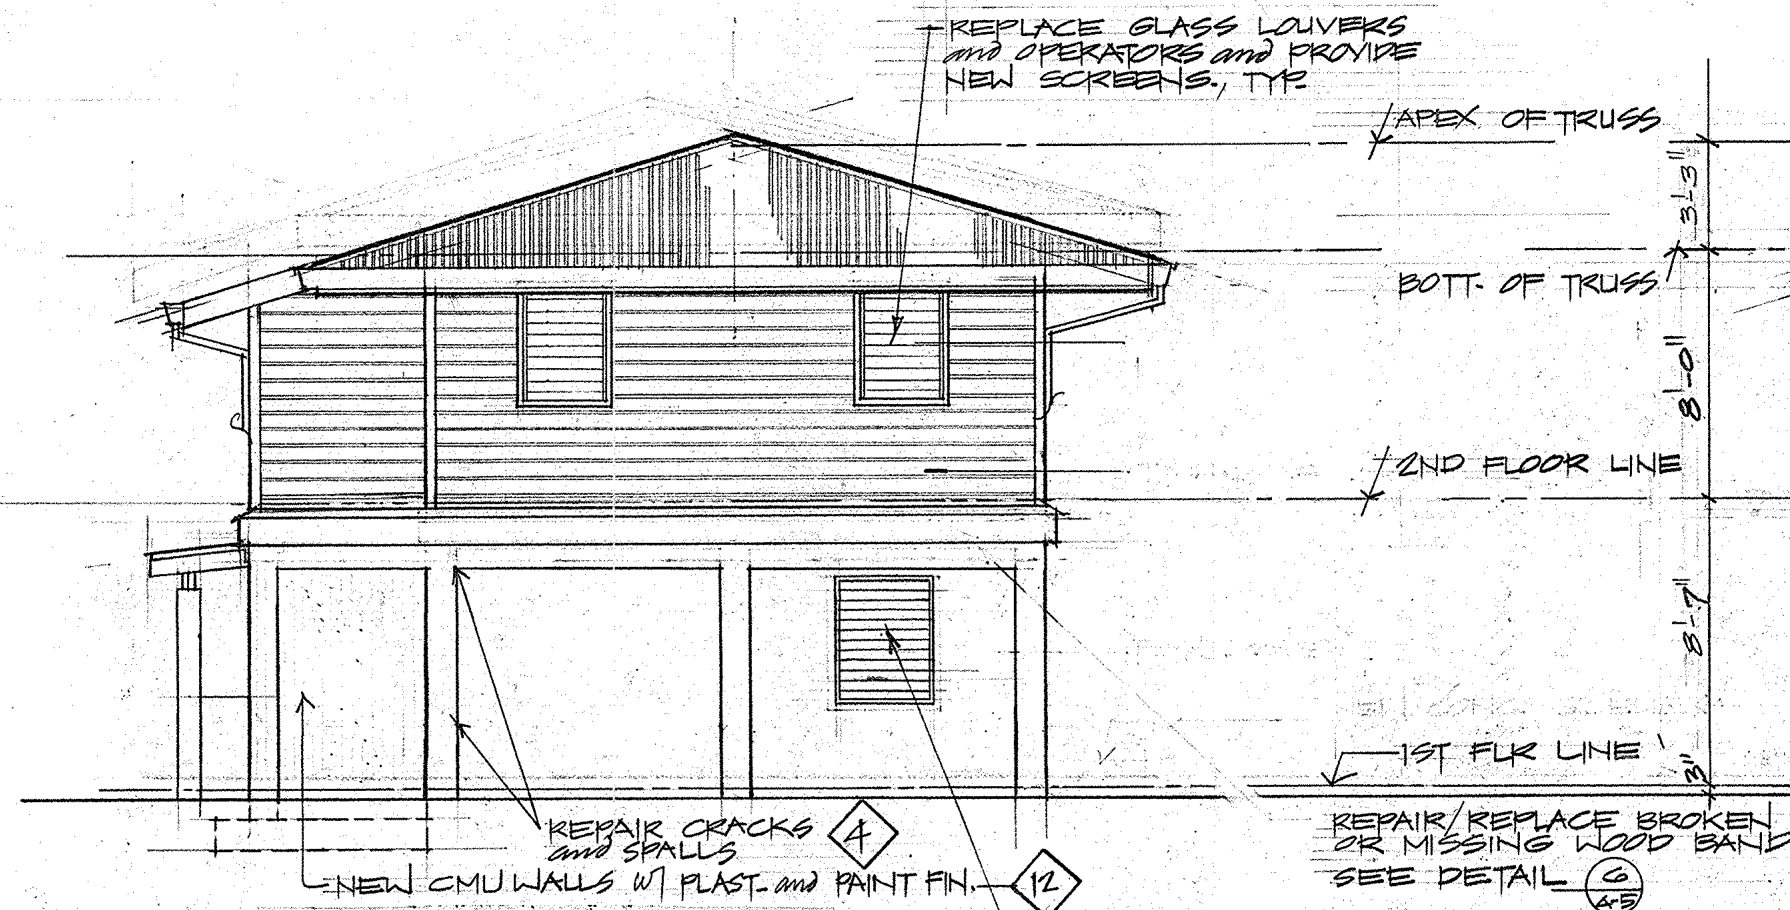


1 LEFT ELEVATION
A-2 SCALE: 1/4" = 1'-0"

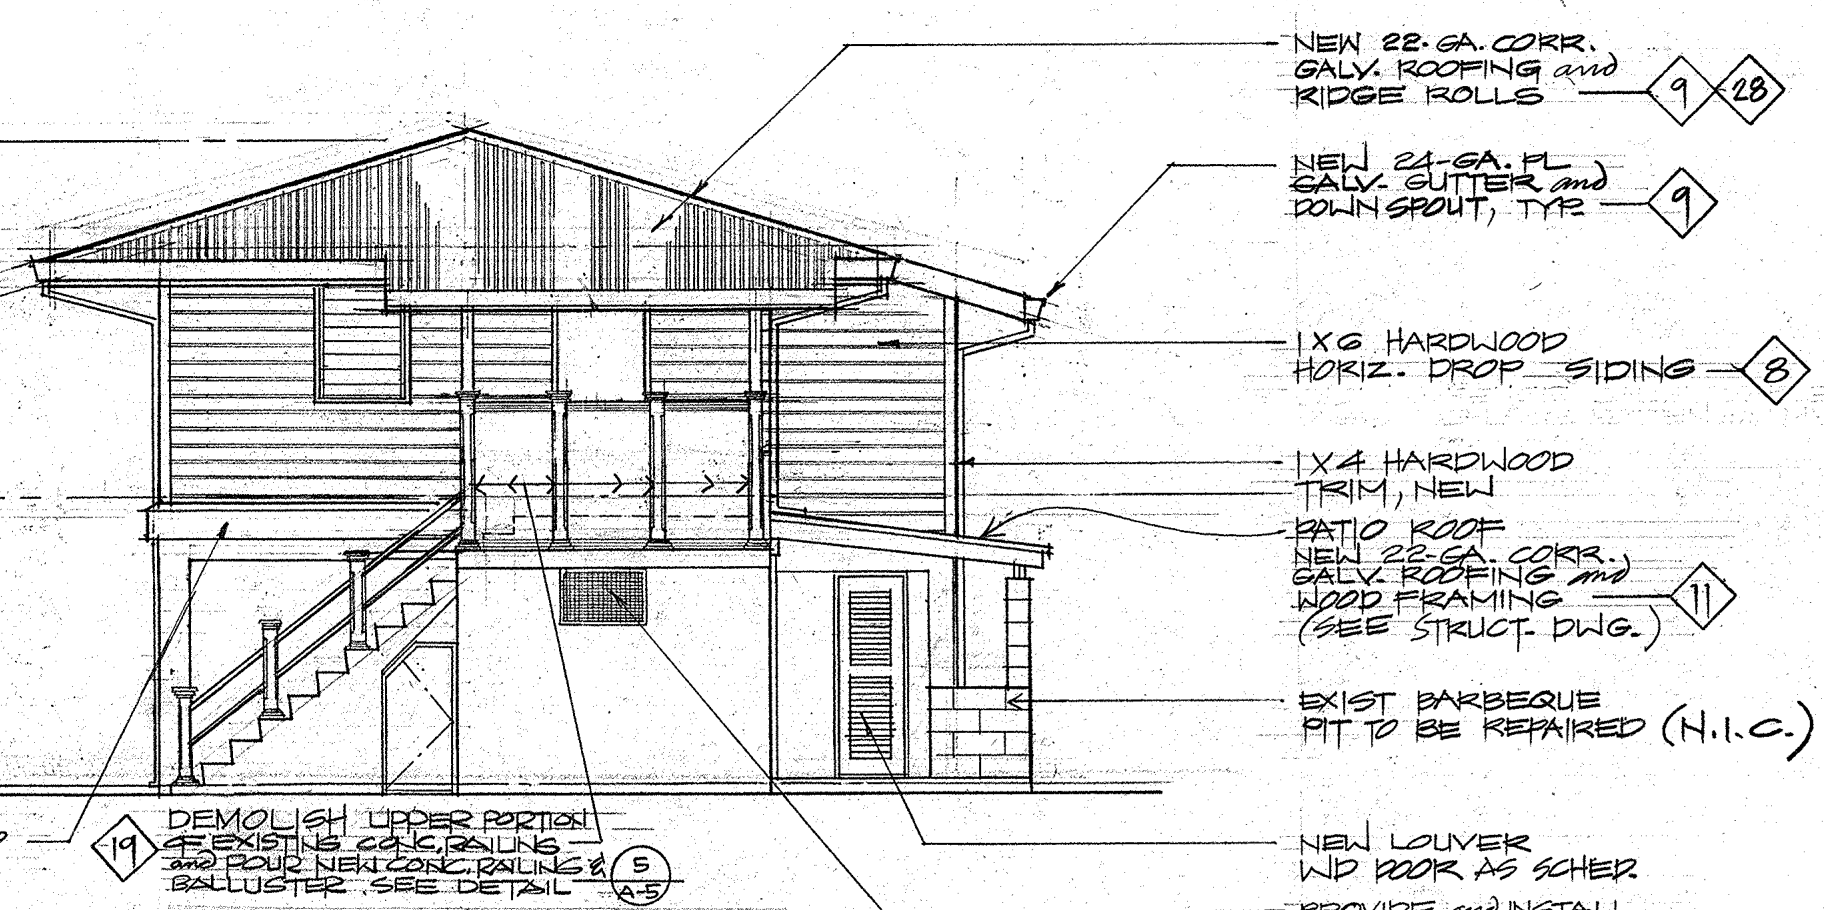


2 RIGHT ELEVATION
A-2 SCALE: 1/4" = 1'-0"

The undersigned does hereby acknowledge that all design and payment issues shown on this page have been explained by the GPT. By signing below, I/we acknowledge that I/we understand and approve these issues.

Owner _____ Date _____
Owner _____ Date _____

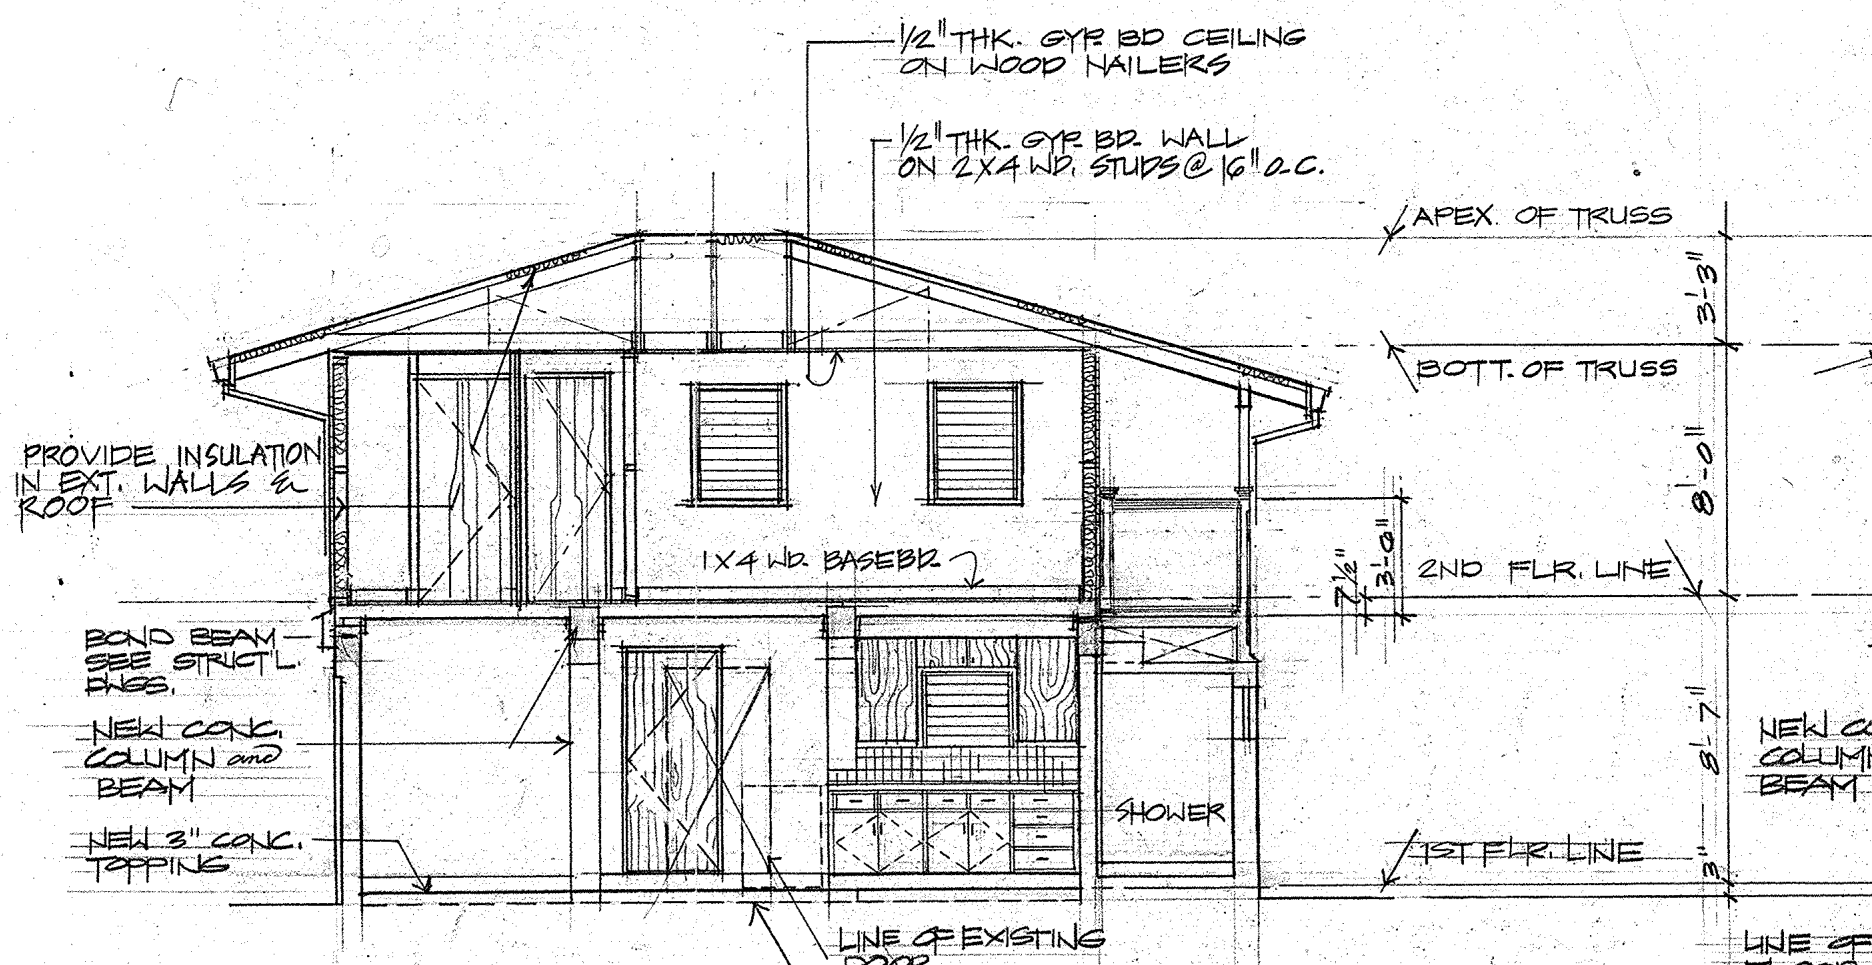


3 SECTION
A-2 SCALE: 1/4" = 1'-0"

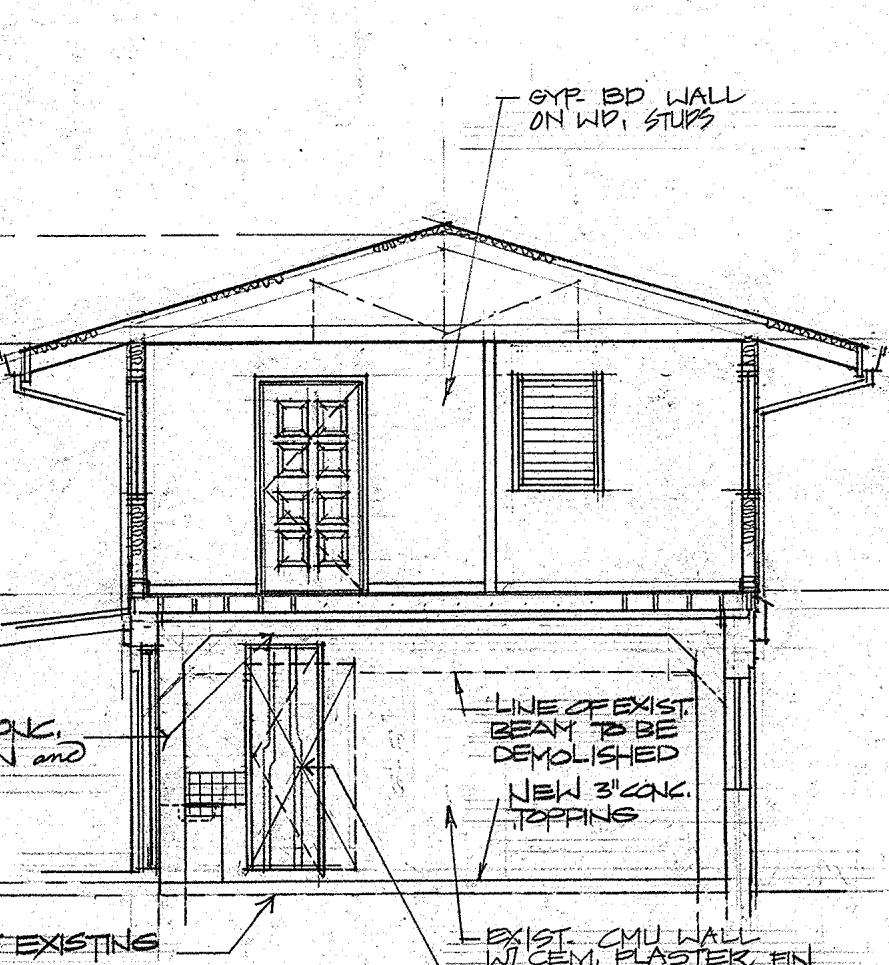


4 SECTION
A-2 SCALE: 1/4" = 1'-0"

INTERIOR ROOM FINISH SCHEDULE											
ROOM NO.	ROOM NAME	FLOOR	BASE	TRIMS COATING	WALLS				CEILING		REMARKS
					A	B	C	D	FINISH	HEIGHT	
101	LIVING DINING KITCHEN	CONC.	RUBBER COVE BASE	-	CMU C.PLAS P	CMU C.PLAS P	CMU C.PLAS P	CMU C.PLAS P	GYR BD RTSP	7'-10 1/2"	NEW CONC. FLOOR
102	BATHROOM-1	CONC.	P	C.T.	CMU C.PLAS P	CMU C.PLAS P	CMU C.PLAS P	CMU C.PLAS P	CONC. P	7'-9 1/2"	EXISTING FLOOR, WALL & NEW CEILING
103	STORAGE	CONC.	-	-	CMU C.PLAS P	CMU C.PLAS R	CMU C.PLAS P	CMU C.PLAS P	CONC. P	8'-0 1/2"	NEW FLOOR, WALLS and CEILING EXCEPT @ WALL 'C'
201	FAMILY ROOM	WOOD	WOOD	-	GYR BR P	GYR BR P	GYR BR P	GYR BR P	GYR BR RTSP	7'-11 1/2"	
202	BEDROOM-1	WOOD	WOOD	-	GYR BR P	GYR BR P	GYR BR P	GYR BR P	GYR BR RTSP	7'-11 1/2"	
203	BEDROOM-2	WOOD	WOOD	-	GYR BR P	GYR BR P	GYR BR P	GYR BR P	GYR BR RTSP	7'-11 1/2"	
204	BATHROOM-2	CONC.	CONC.	C.T.	CMU C.PLAS C.T.	CMU C.PLAS C.T.	CMU C.PLAS C.T.	CMU C.PLAS C.T.	GYR BR P	7'-11 1/2"	H.T. VARIES

CONC. CONCRETE
 CMU CONCRETE MASONRY UNIT
 C.T. CERAMIC TILE
 C-PLAS CEMENT PLASTER
 GYR BR GYPSUM BOARD
 YT VINYL TILE
 P PAINTED
 RTSP ROUGH TEXTURED SPRAY PAINT

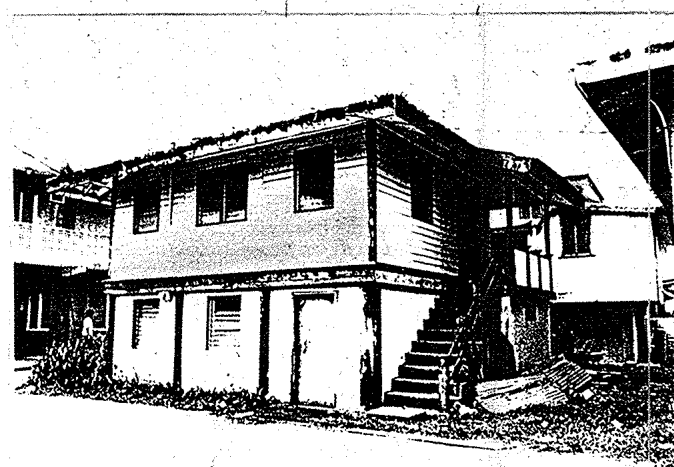

ELEVATION (FRONT/RIGHT)

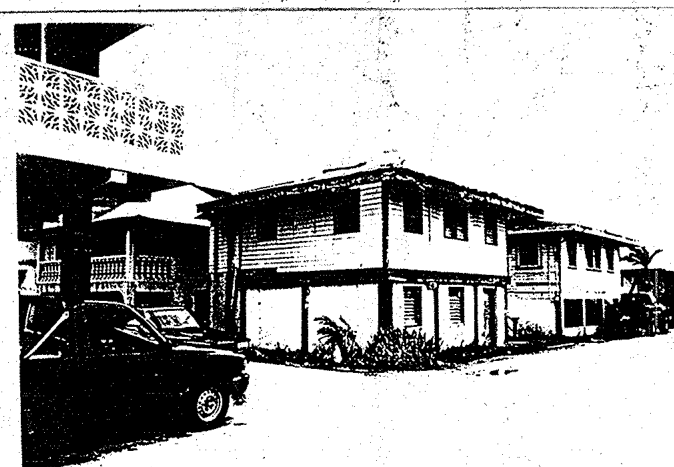

ELEVATION (LEFT/FRONT)




ELEVATION (REAR)




ELEVATION (LEFT)

REVISION	DATE	BY	DESCRIPTION	APPROVED
PROJECT NO.			GUAM PRESERVATION TRUST.	
CONTRACT NO. PTA-031				
DESIGNED BY: KAW	PROJECT: RESTORATION TO THE EXISTING HISTORICAL BUILDING		MENO RESIDENCE	
DRAWN BY: JHA	LOT NO. 67		INARAJAN, GUAM	
CHECKED BY: KAW	SHEET CONTENTS		LEFT AND RIGHT ELEVATIONS, SECTIONS, INTERIOR ROOM AND FINISH SCHEDULE, PHOTO ELEVATIONS	
RECOMMENDED APPROVAL			DATE:	
GUAM PRESERVATION TRUST			DATE:	
willy a. watson, aia architect			DRAWER NO:	
			DRAWING NUMBER A-2	
			SHEET 3 OF 14	

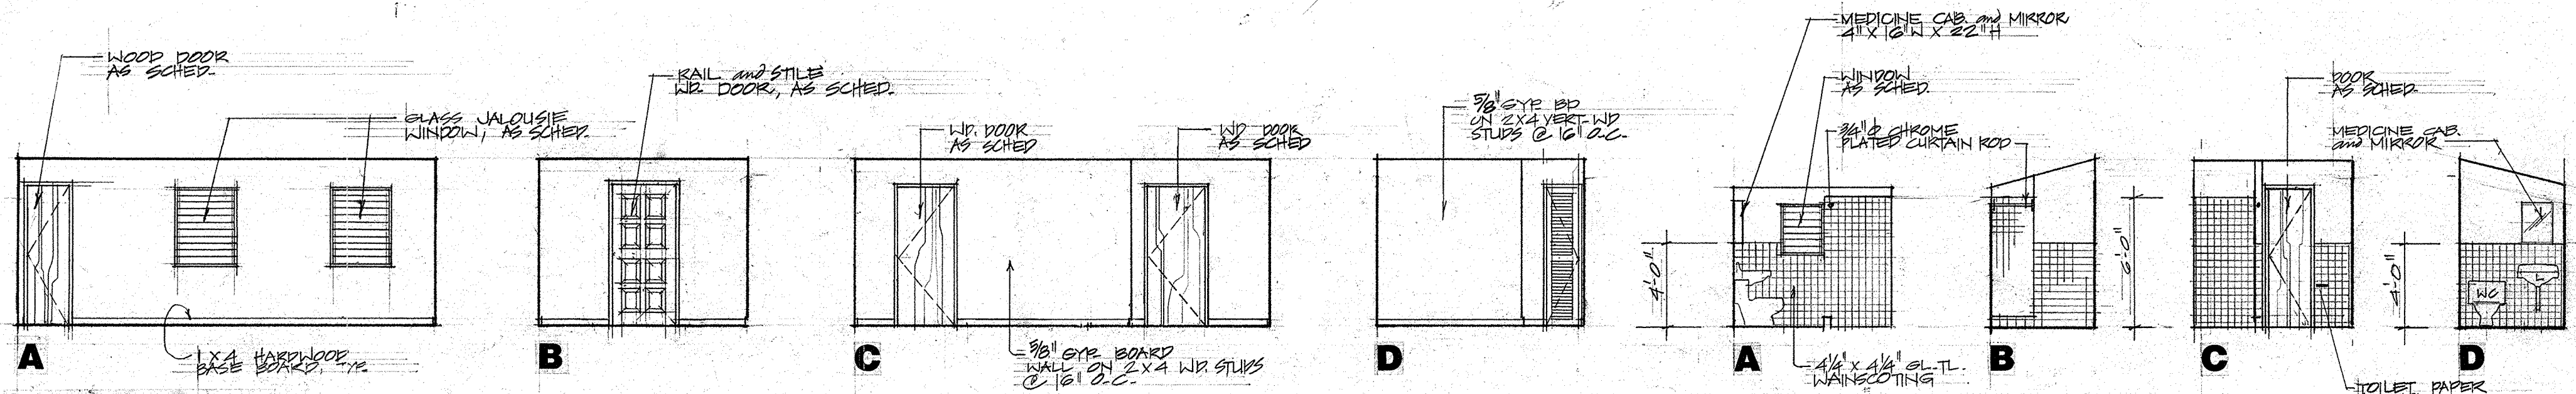


FAMILY ROOM


BATHROOM - 2

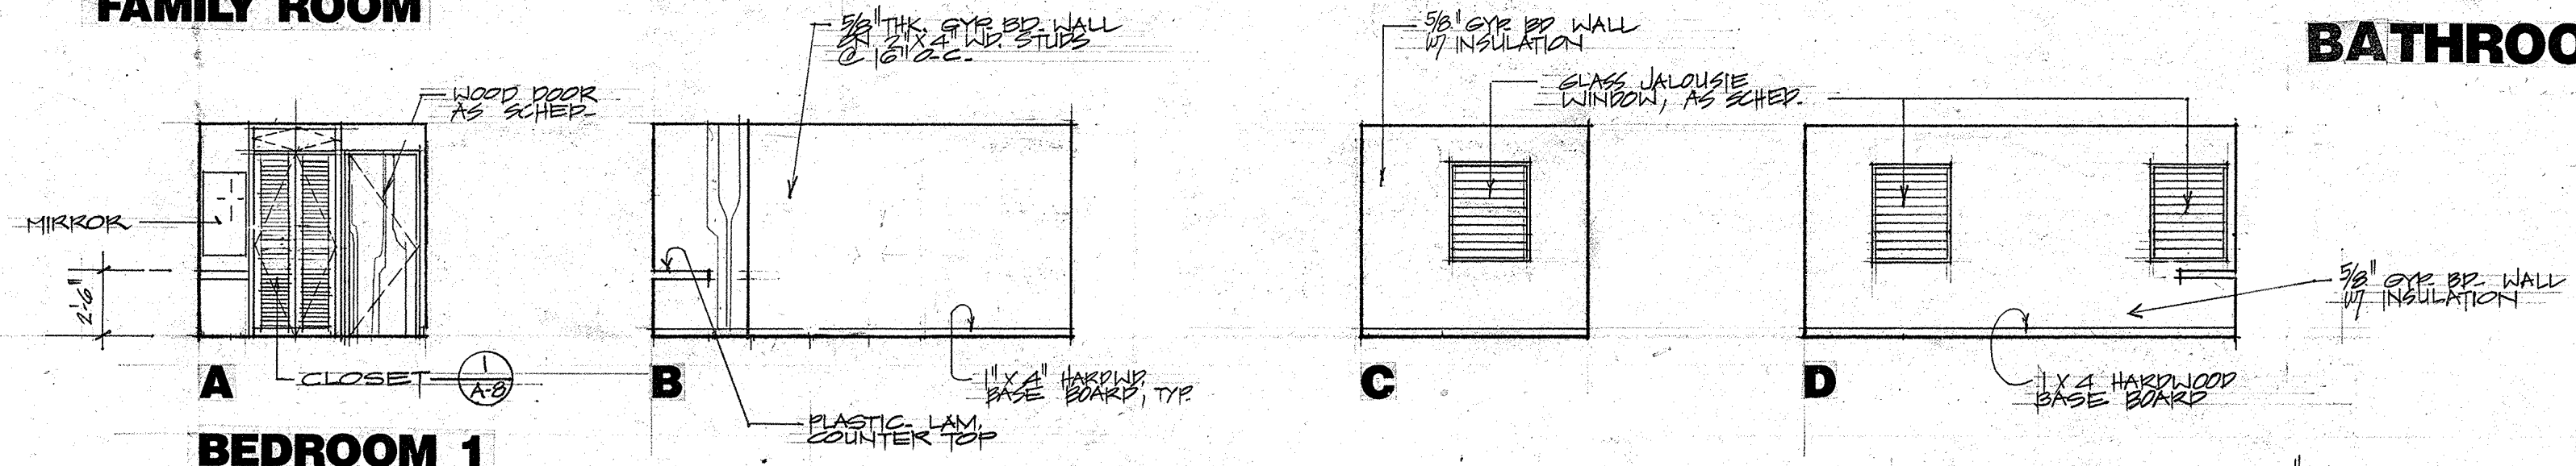

BEDROOM 1

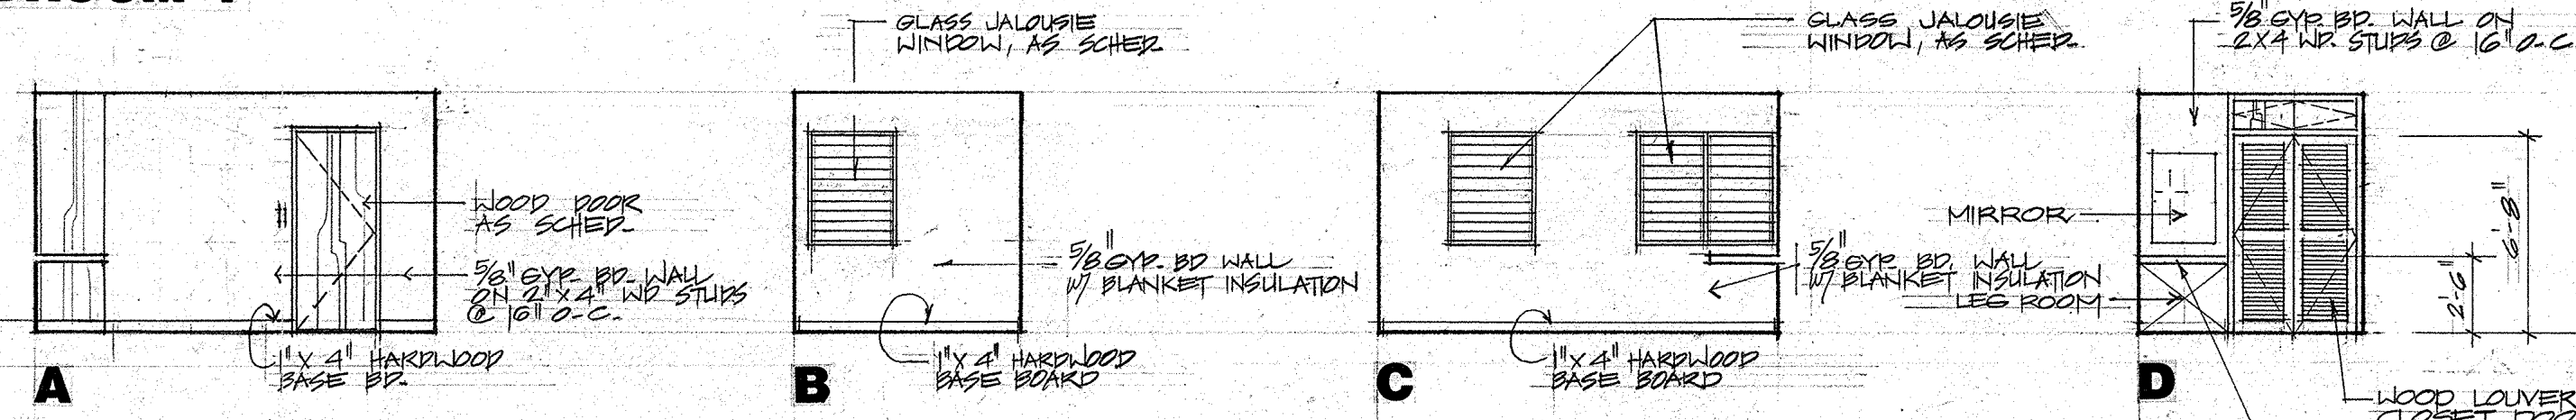

BEDROOM 2

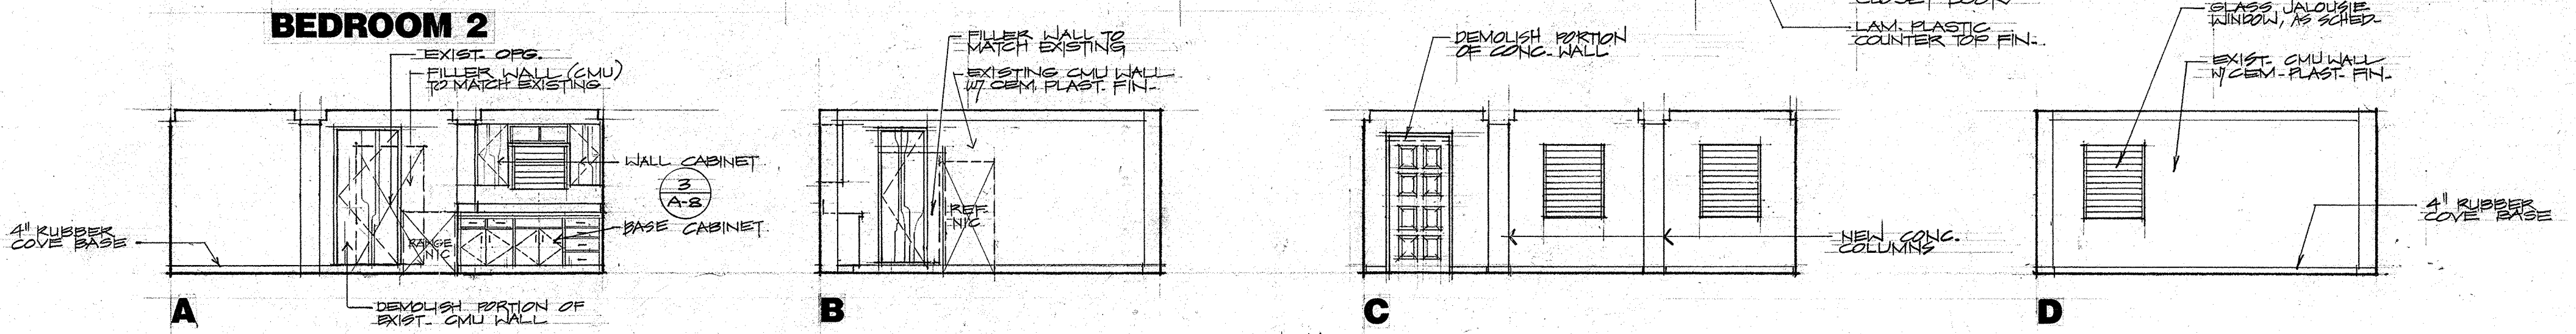

LIVING/DINING/KITCHEN

BATHROOM - 1








1 INTERIOR ELEVATIONS

SCALE 1/4" = 1'-0"

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CONTRACT NO. PTA-031				
DESIGNED BY: WAW			PROJECT: RESTORATION TO THE EXISTING HISTORICAL BUILDING MENO RESIDENCE LOT NO. 67 INARAJAN, GUAM	
DRAWN BY: WAW			SHEET CONTENTS INTERIOR ELEVATIONS	
CHECKED BY: WAW			RECOMMENDED APPROVAL DATE:	
			GUAM PRESERVATION TRUST DATE:	
			willy a. watson, aia architect DRAWER NO: _____ DRAWING NUMBER: A-3 SHEET 4 OF 14	





1 REFLECTED CEILING PLAN
SCALE 1/4" = 1'-0"

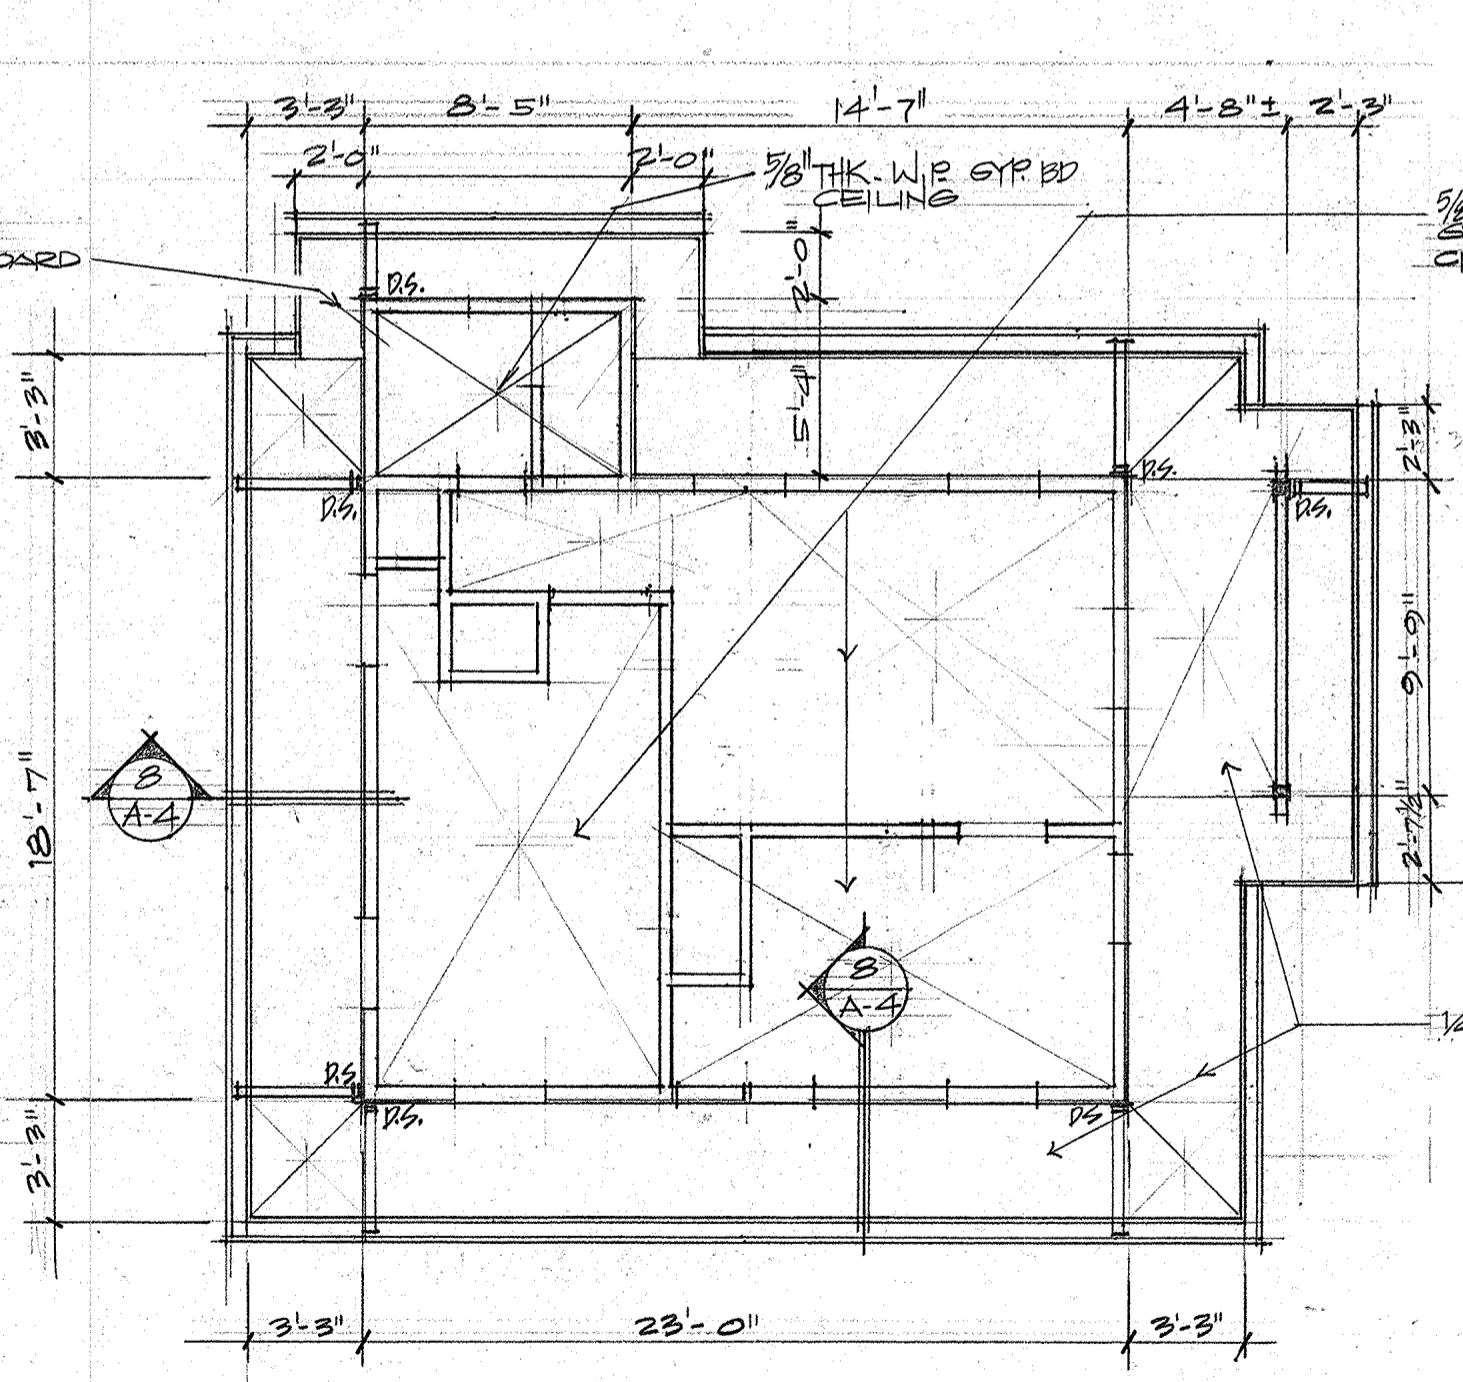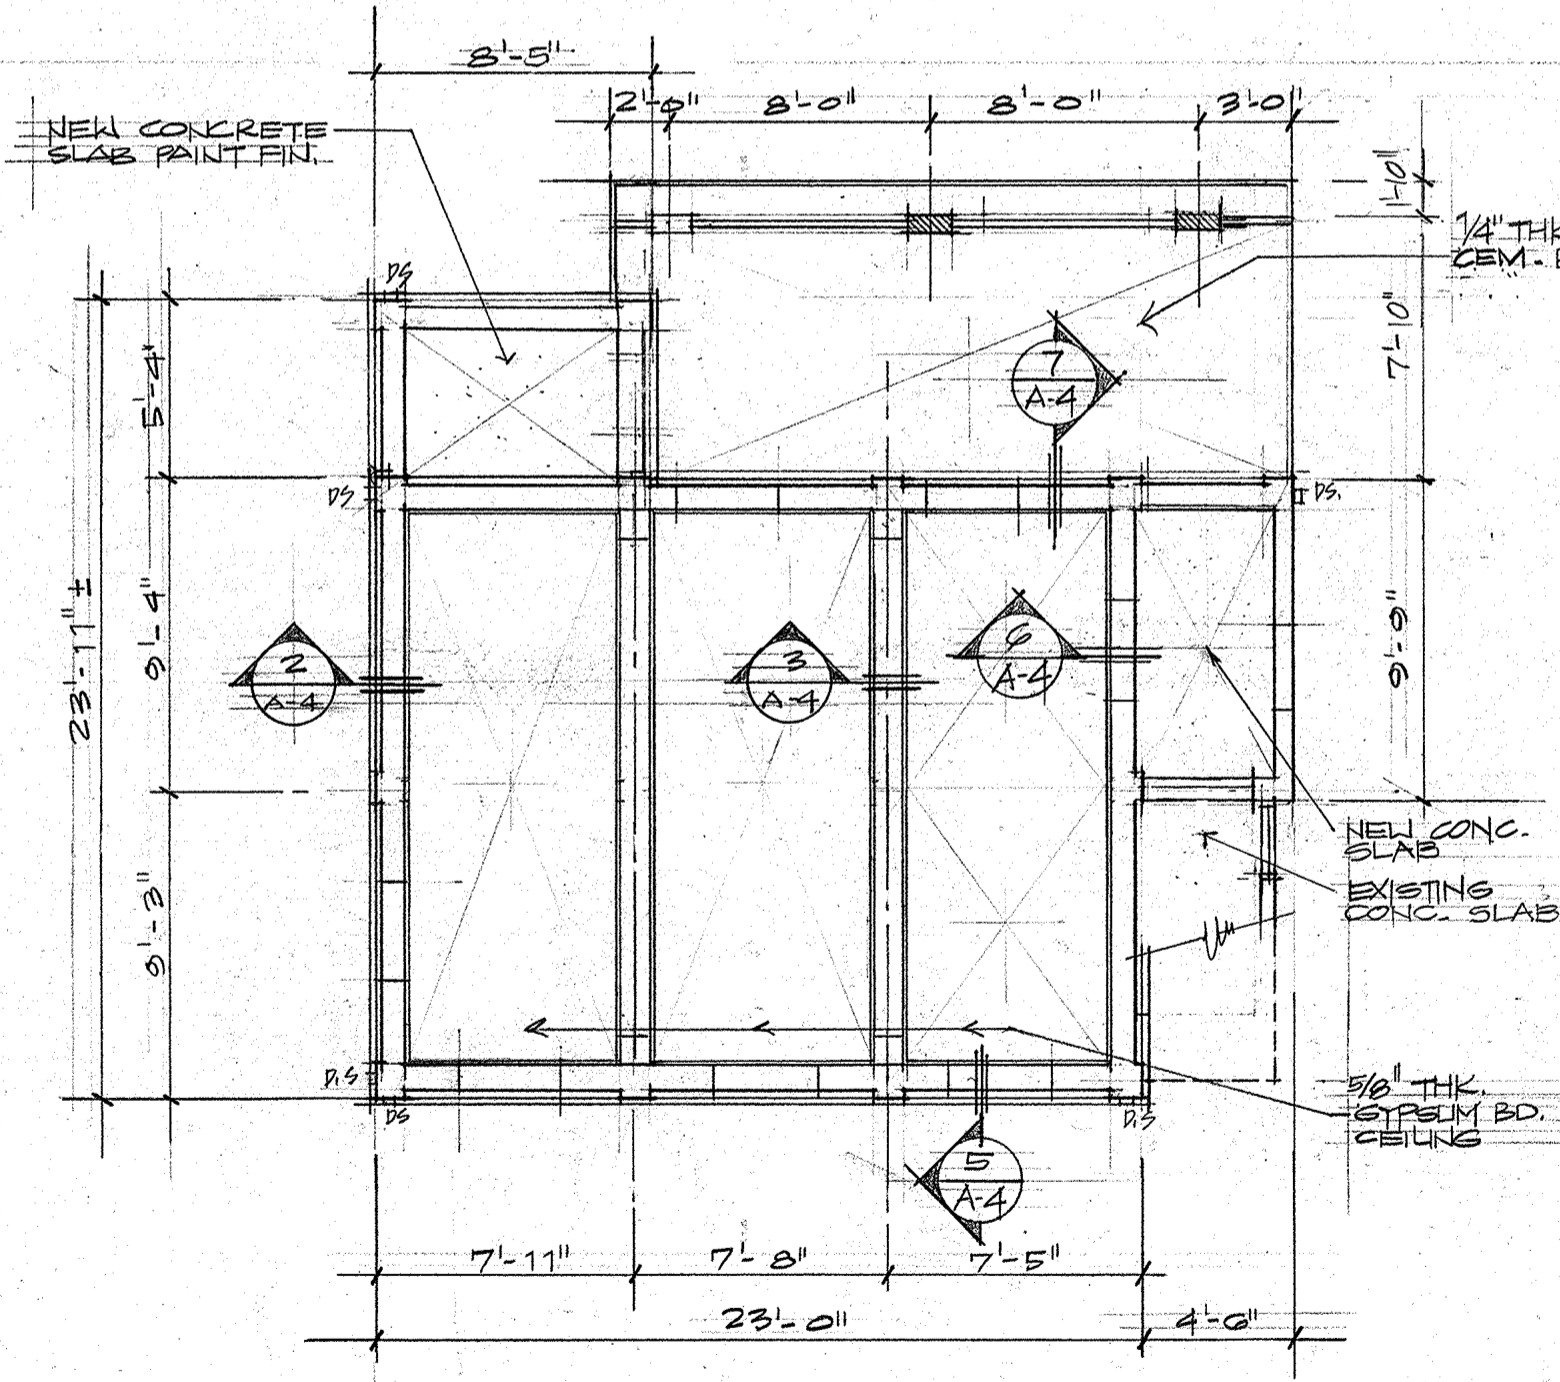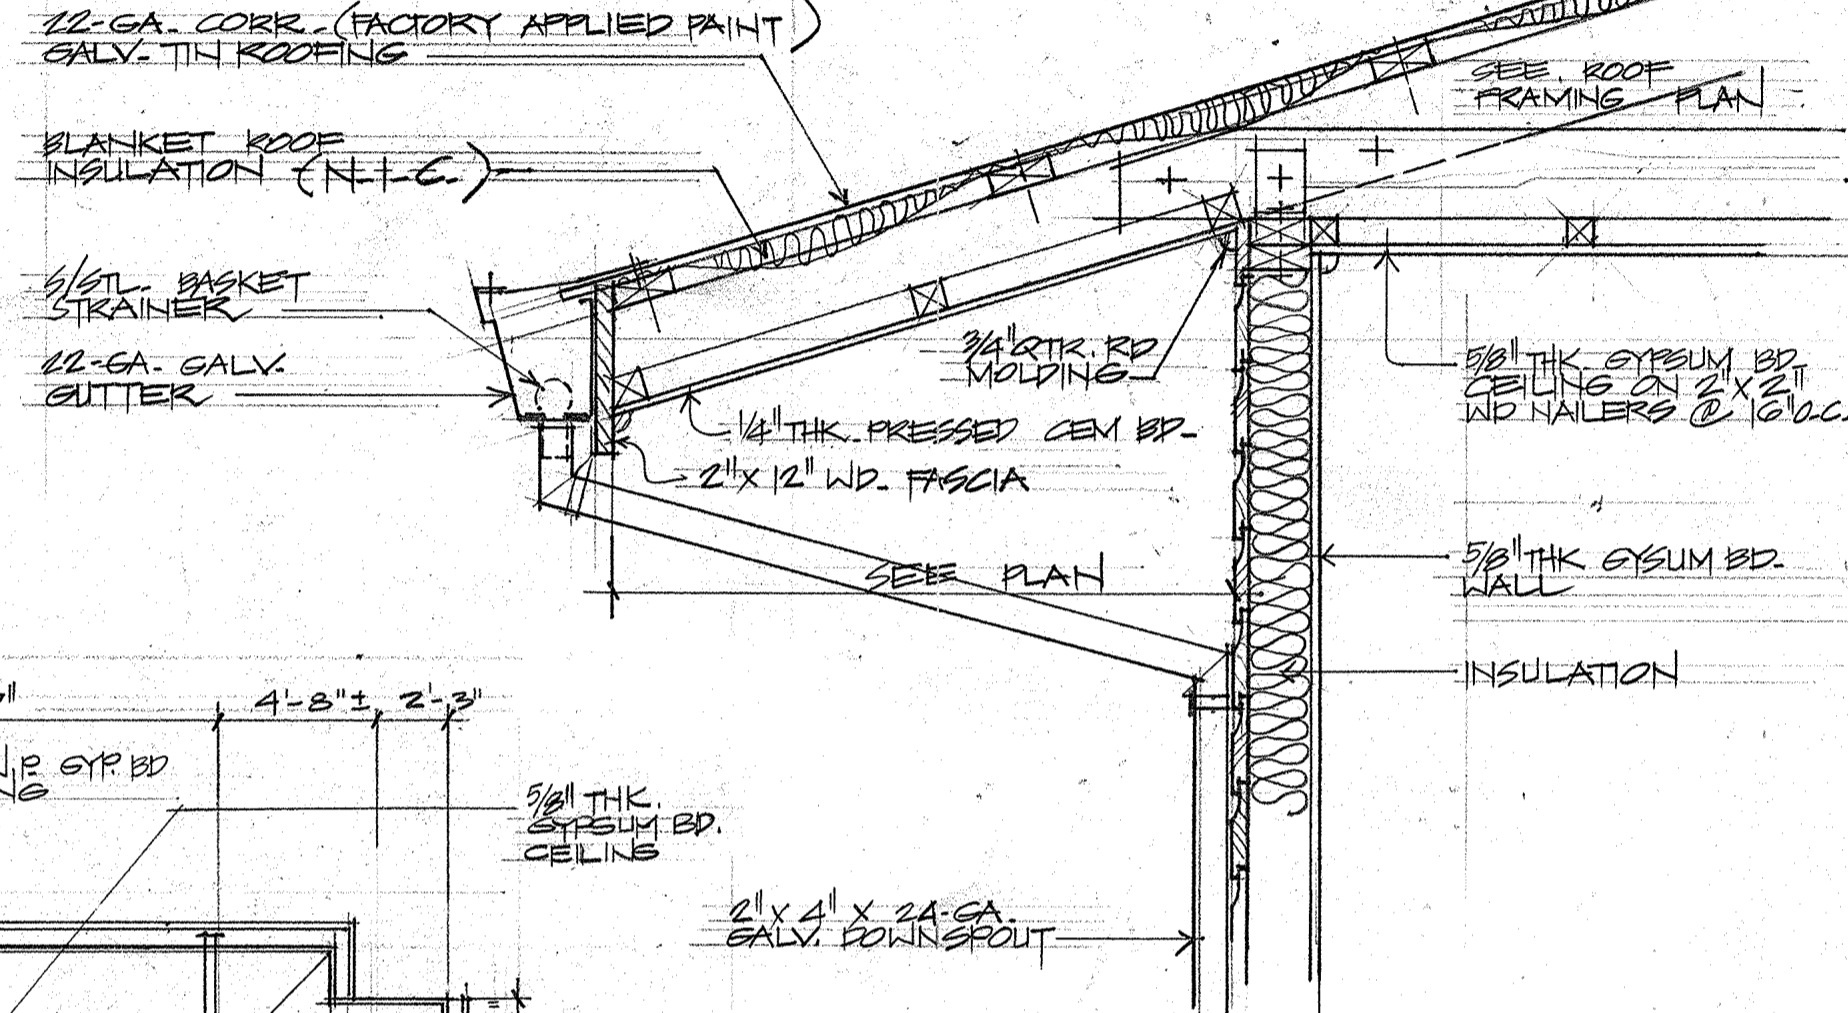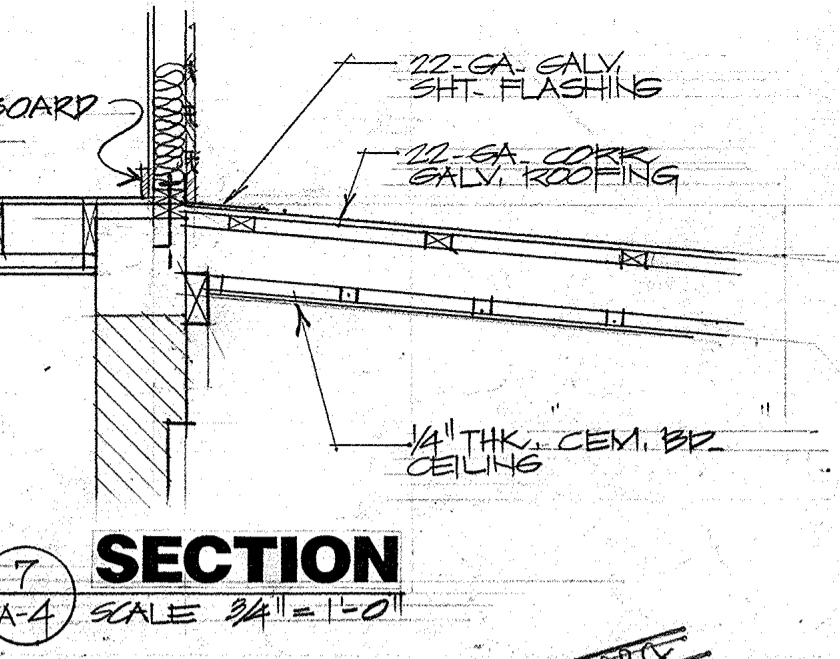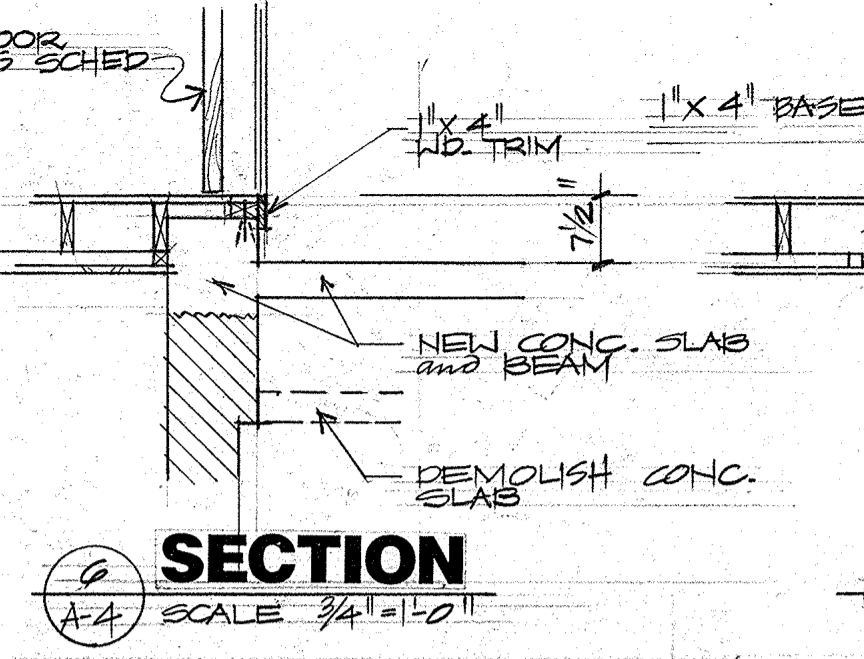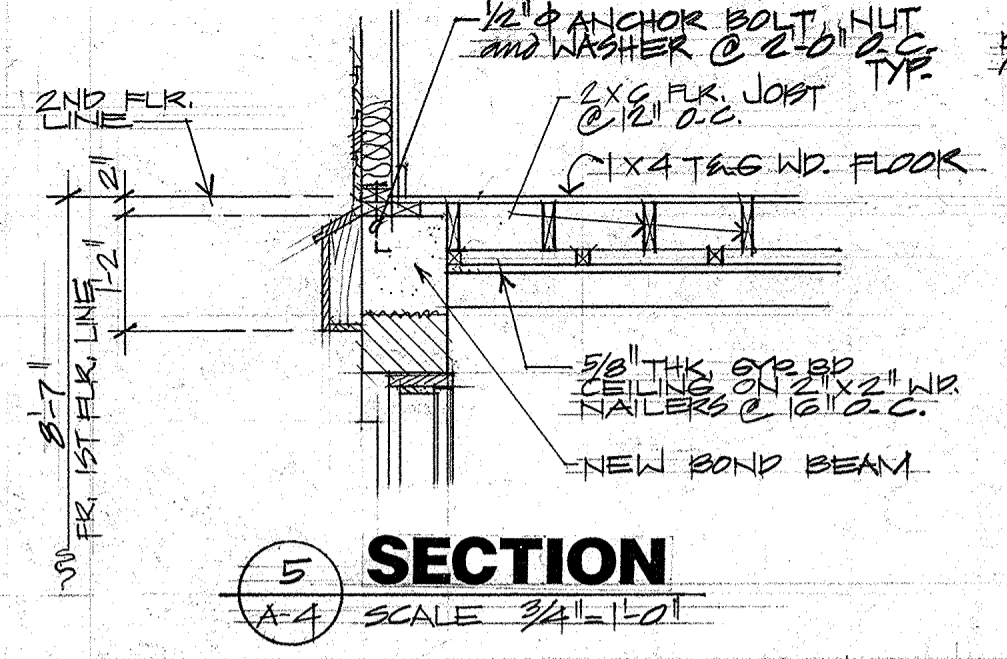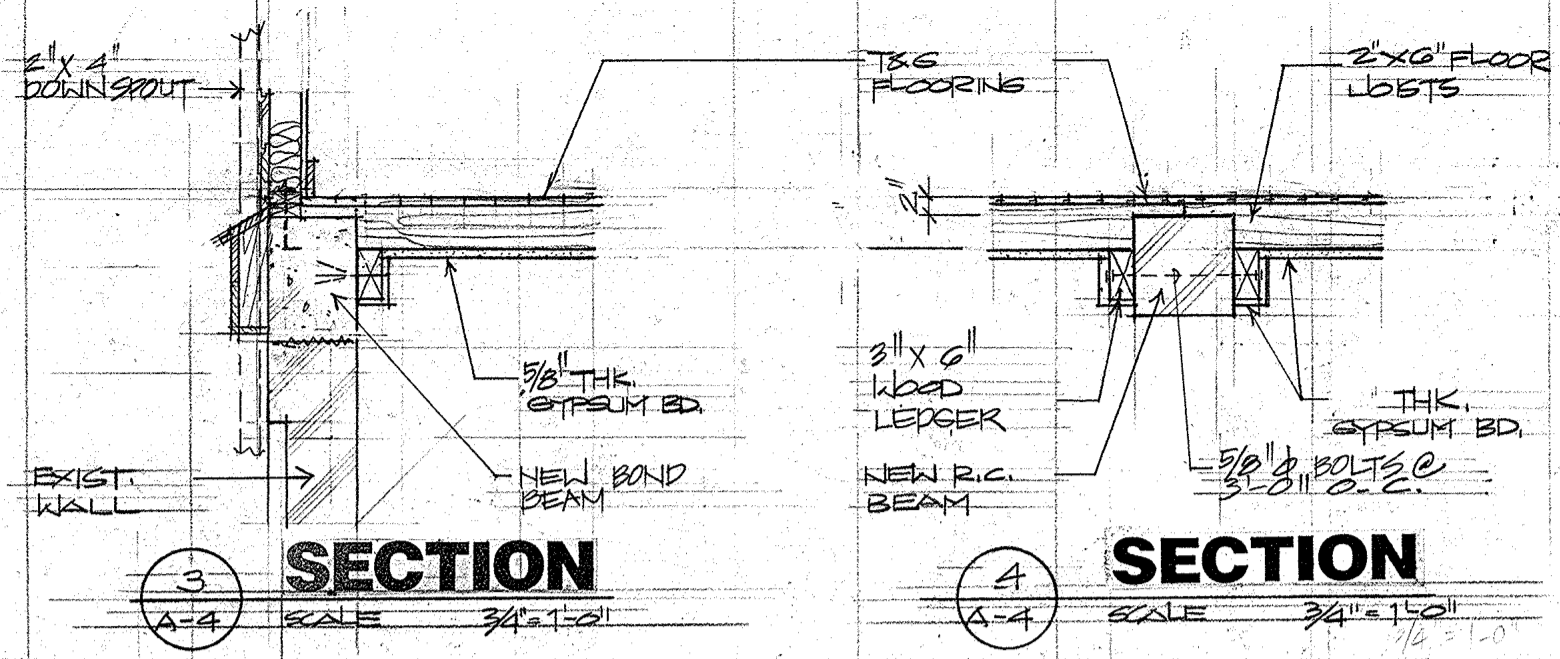2 REFLECTED CEILING PLAN
SCALE 1/4" = 1'-0"

8 SECTION
SCALE 1/2" = 1'-0"


REVISION	DATE	BY	DESCRIPTION	APPROVED
PROJECT NO.				
CONTRACT NO. PTD 031				
DESIGNED BY: WAK				
DRAWN BY: ADS				
CHECKED BY: WAK				
GUAM PRESERVATION TRUST				
PROJECT: RESTORATION TO THE EXISTING HISTORICAL BUILDING				
MENO RESIDENCE LOT NO. 67 INARAJAN, GUAM				
SHEET CONTENTS REFLECTED CEILING PLANS AND DETAILS				
RECOMMENDED APPROVAL				DATE:
GUAM PRESERVATION TRUST				DATE:
willy a. watson, aia architect				DRAWER NO:
				DRAWING NUMBER A-4
				SHEET 5 OF 14

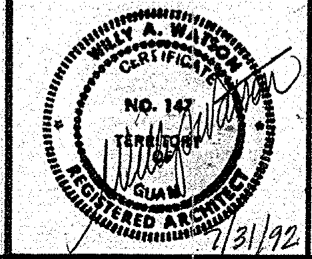

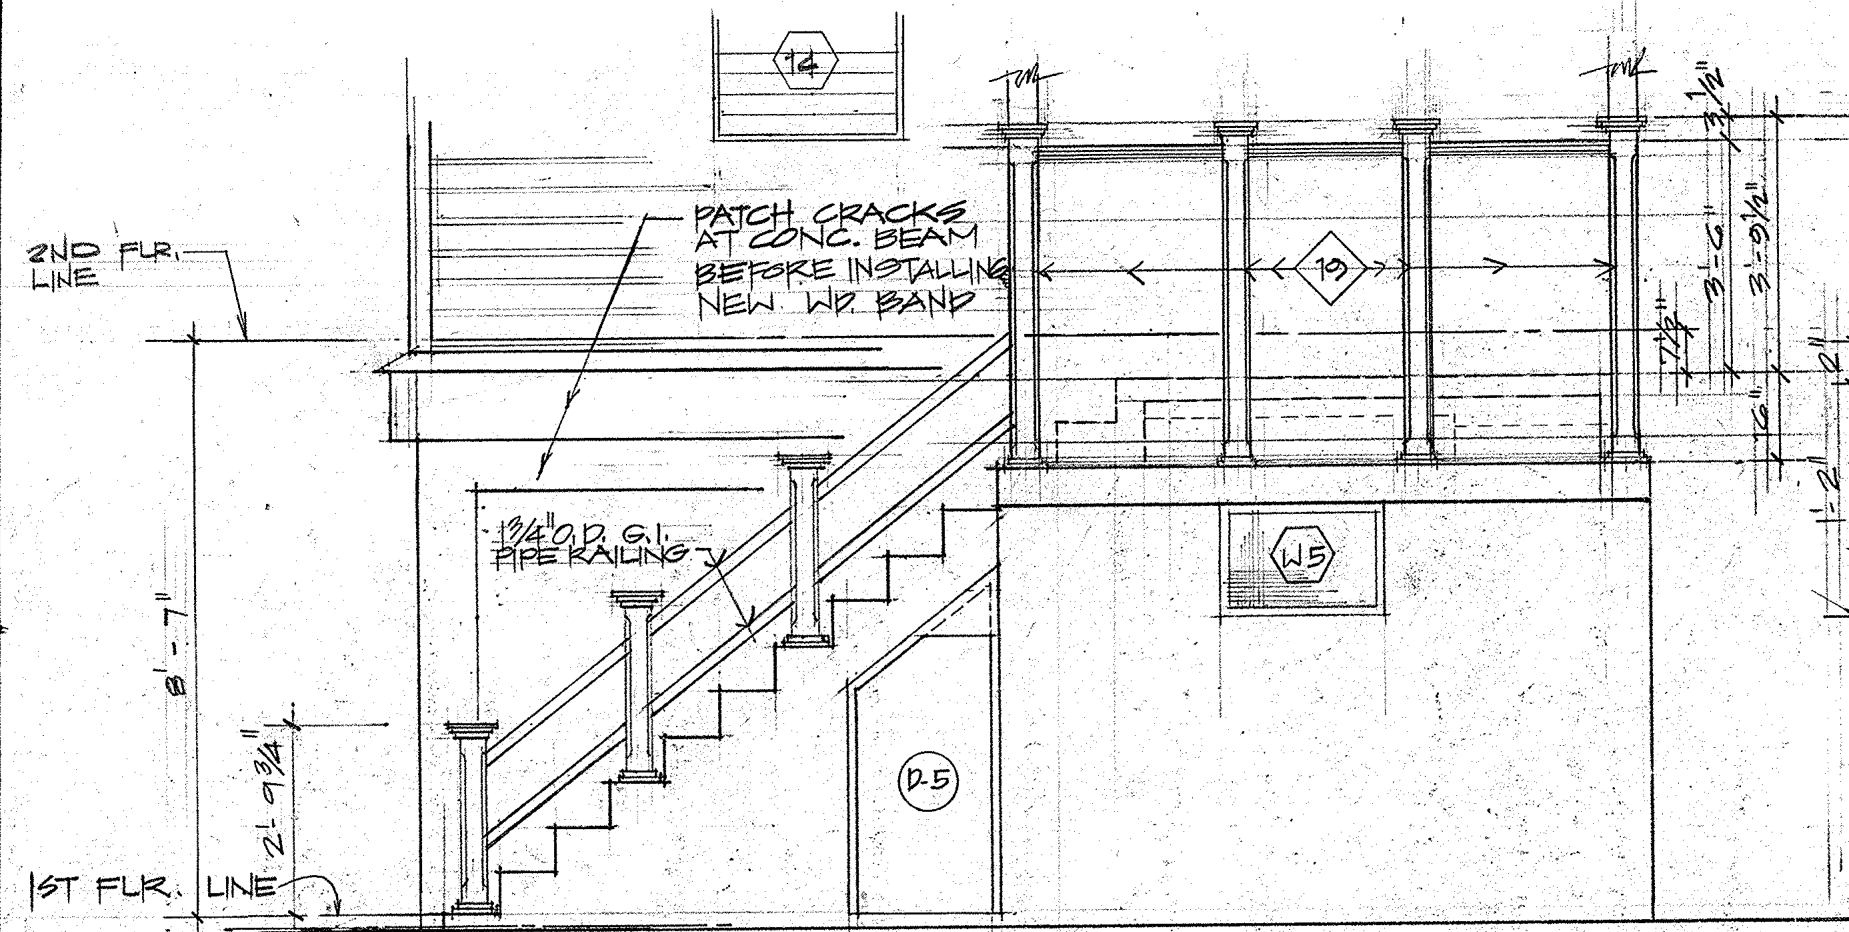


3 ELEVATION

A-5 SCALE 1/2" = 1'-0"

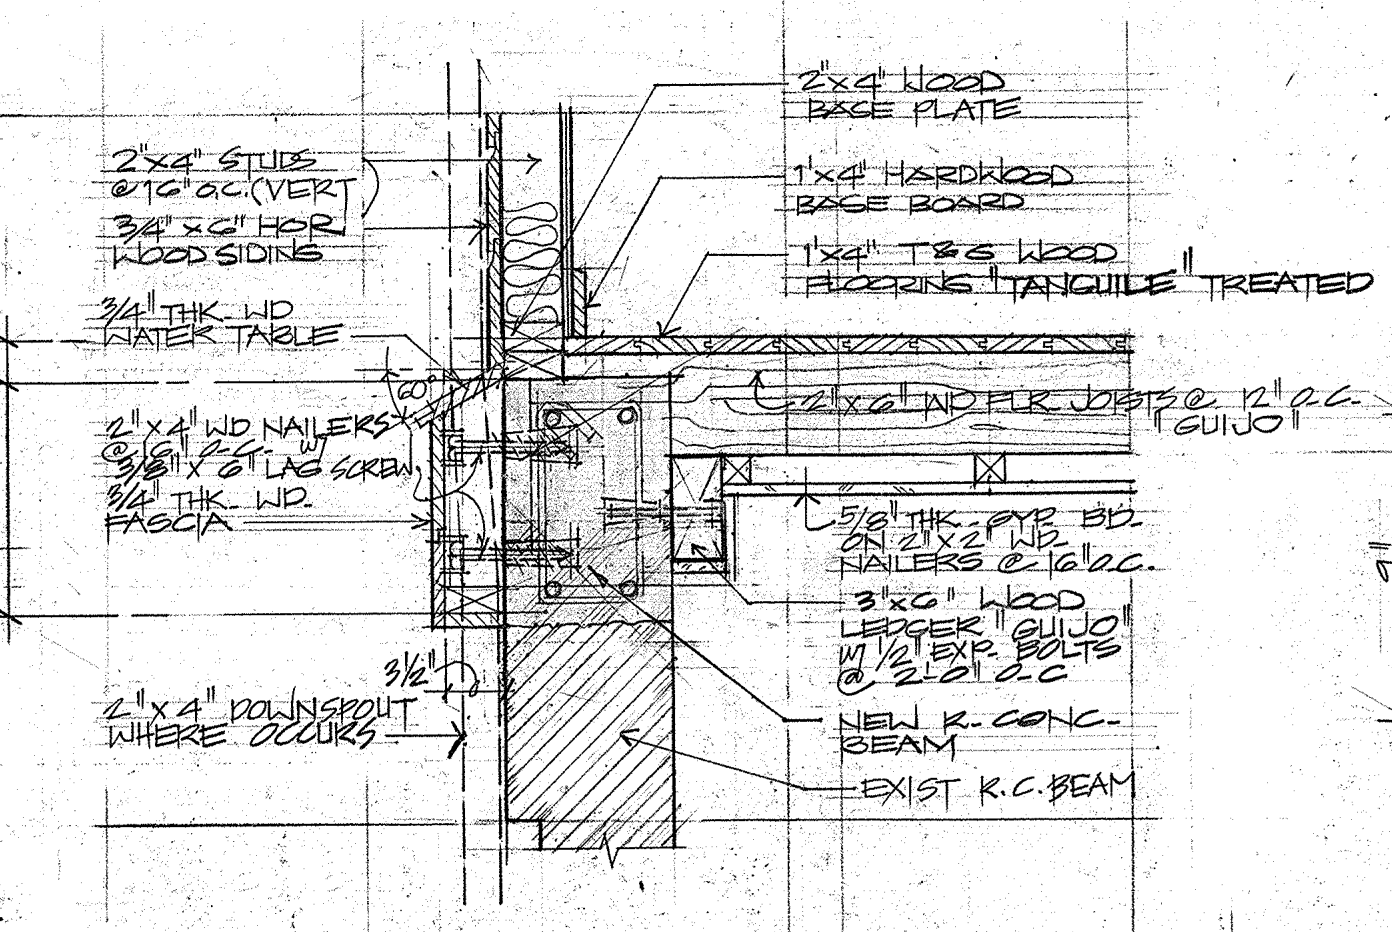

6 DETAIL (EXISTING)

A-5 SCALE 1 1/2" = 1'-0"

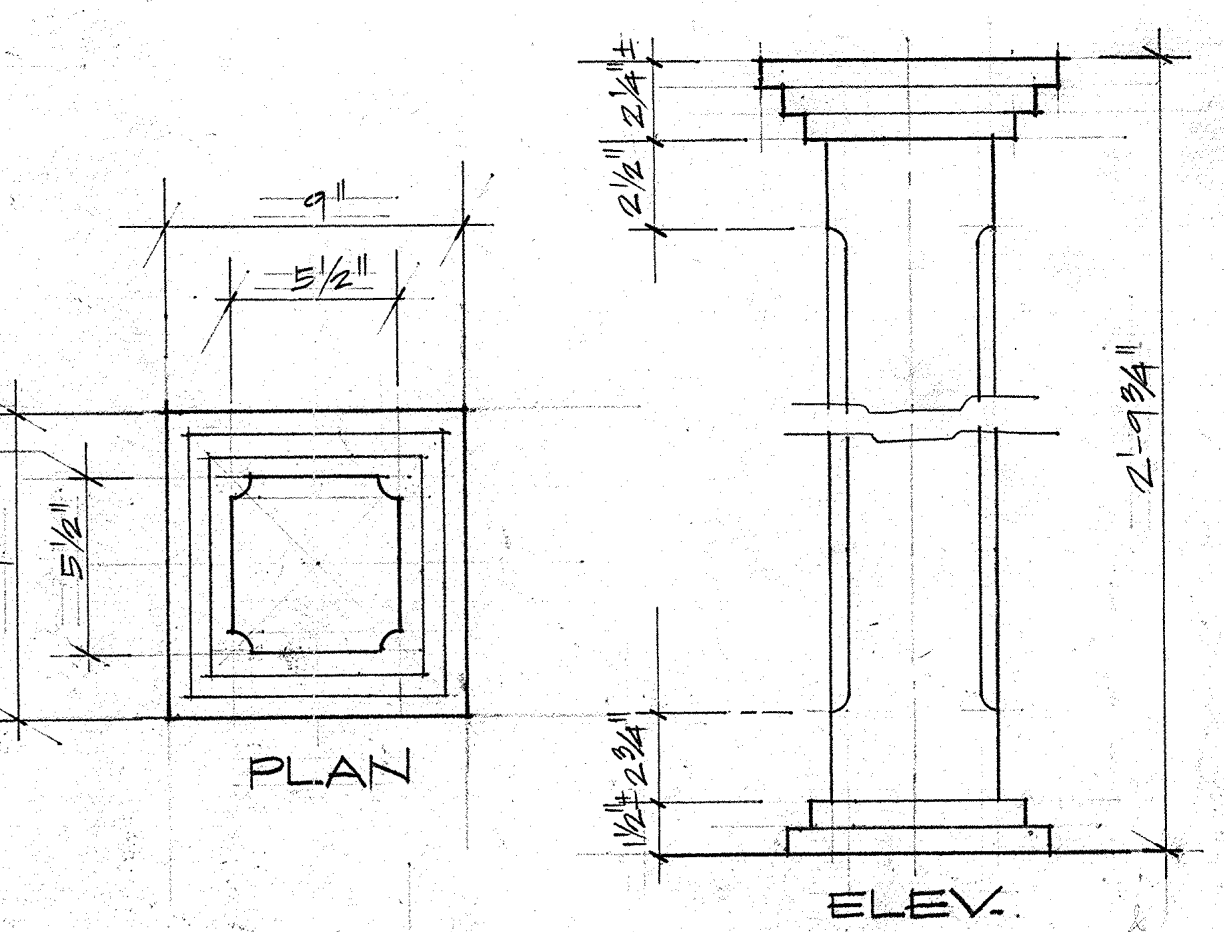


7 DETAIL (EXIST BALUSTERS)

A-5 SCALE 3" = 1'-0"


GENERAL NOTES

1. CRACKS and SPALLS ARE PREDOMINANTLY ALL OVER THE CONC. STAIR and RAILING.
2. CONTRACTOR HAS TO VERIFY EXTEND OF REPAIR ESPECIALLY AFTER CLEANING IS PERFORMED.
3. SURFACE CLEANING OF STRUCTURES SHALL BE UNDERTAKEN W/ THE GENTLEST MEANS POSSIBLE, SUCH AS LOW PRESSURE WATER and DETERGENT, USING NATURAL BRISTLE BRUSHES. APPLYING HIGH PRESSURE WATER CLEANING METHOD THAT WILL DAMAGE HISTORIC MASONRY OR ARCHITECTURAL CONC. SURFACES ARE NOT ALLOWED.
4. WOOD SIDING, WOOD BAND, WINDOW & DOOR FRAMES ARE TO BE RETAINED EXCEPT ON DETERIORATED WOOD WHICH ARE TO BE REPLACED WITH COMPATIBLE SUBSTITUTE MATERIAL AND RESTORE TO ITS FORMER SHAPE and FEATURE.
5. APPLY CHEMICAL WOOD PRESERVATIVES TO WOOD FEATURES SUCH AS TRIM ENDS, JOINTS, BEAMS and FLOOR JOIST ENDS THAT ARE EXPOSED TO DECAY HAZARDS and ARE TRADITIONALLY UNPAINTED.
6. EVALUATING THE OVERALL CONDITION OF THE WOOD WHETHER MORE THAN PROTECTION and MAINTENANCE ARE REQUIRED WILL BE SUBJECT TO THE APPROVAL OF THE CONTRACTING OFFICER.

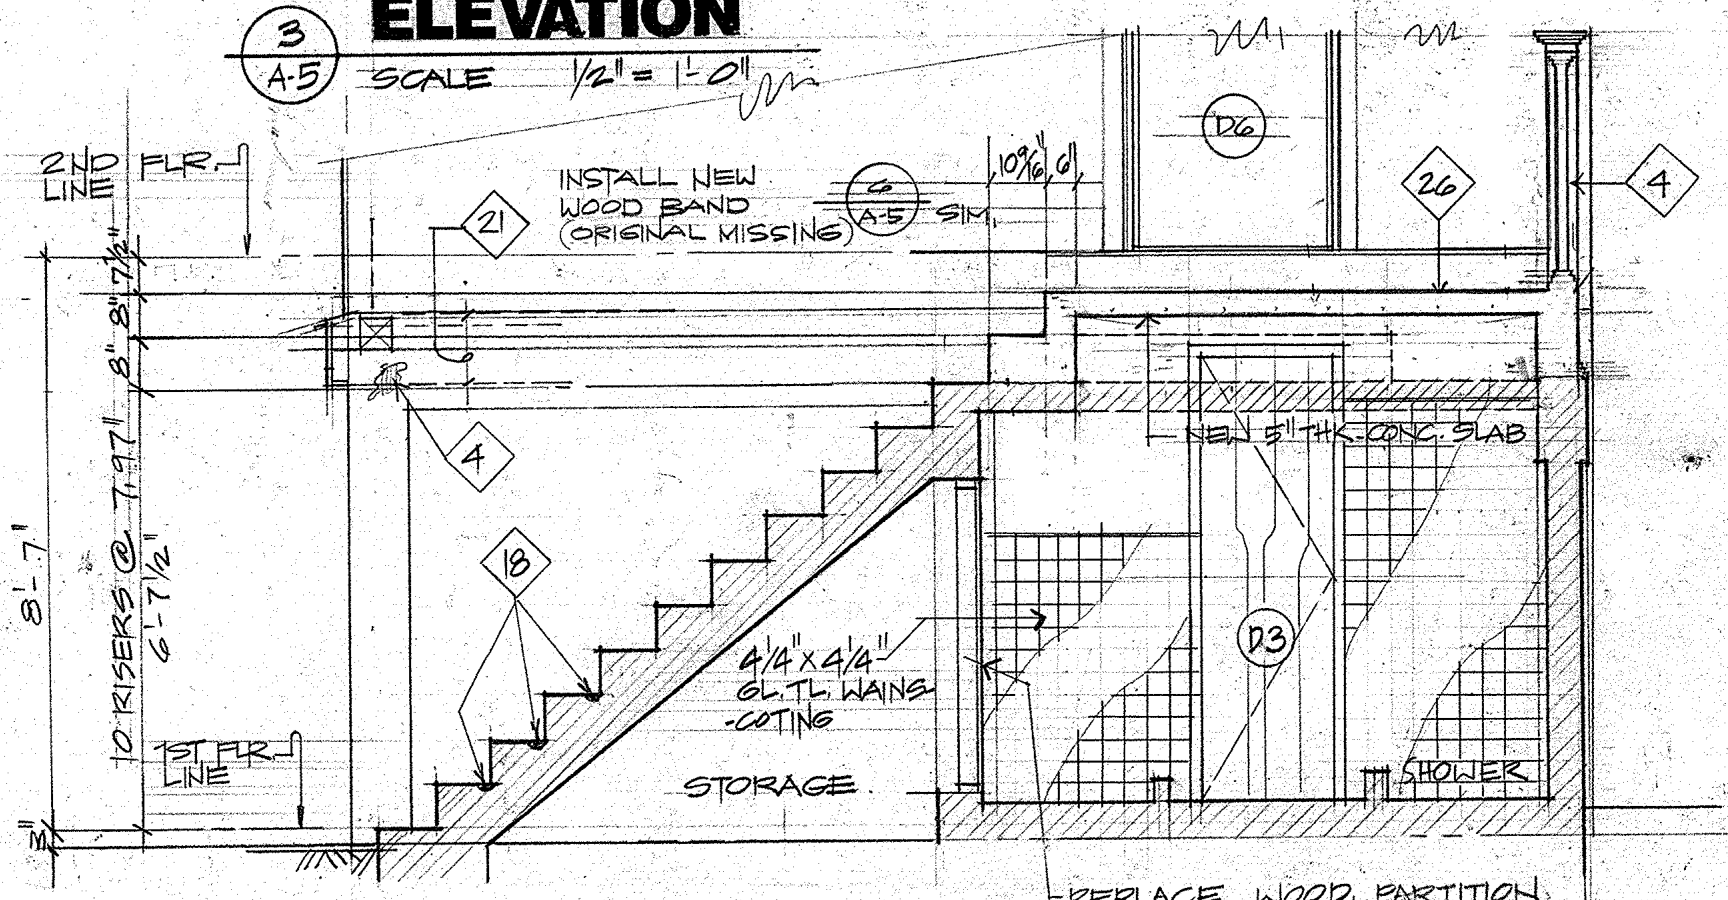

2 SECTION

A-5 SCALE 1/2" = 1'-0"

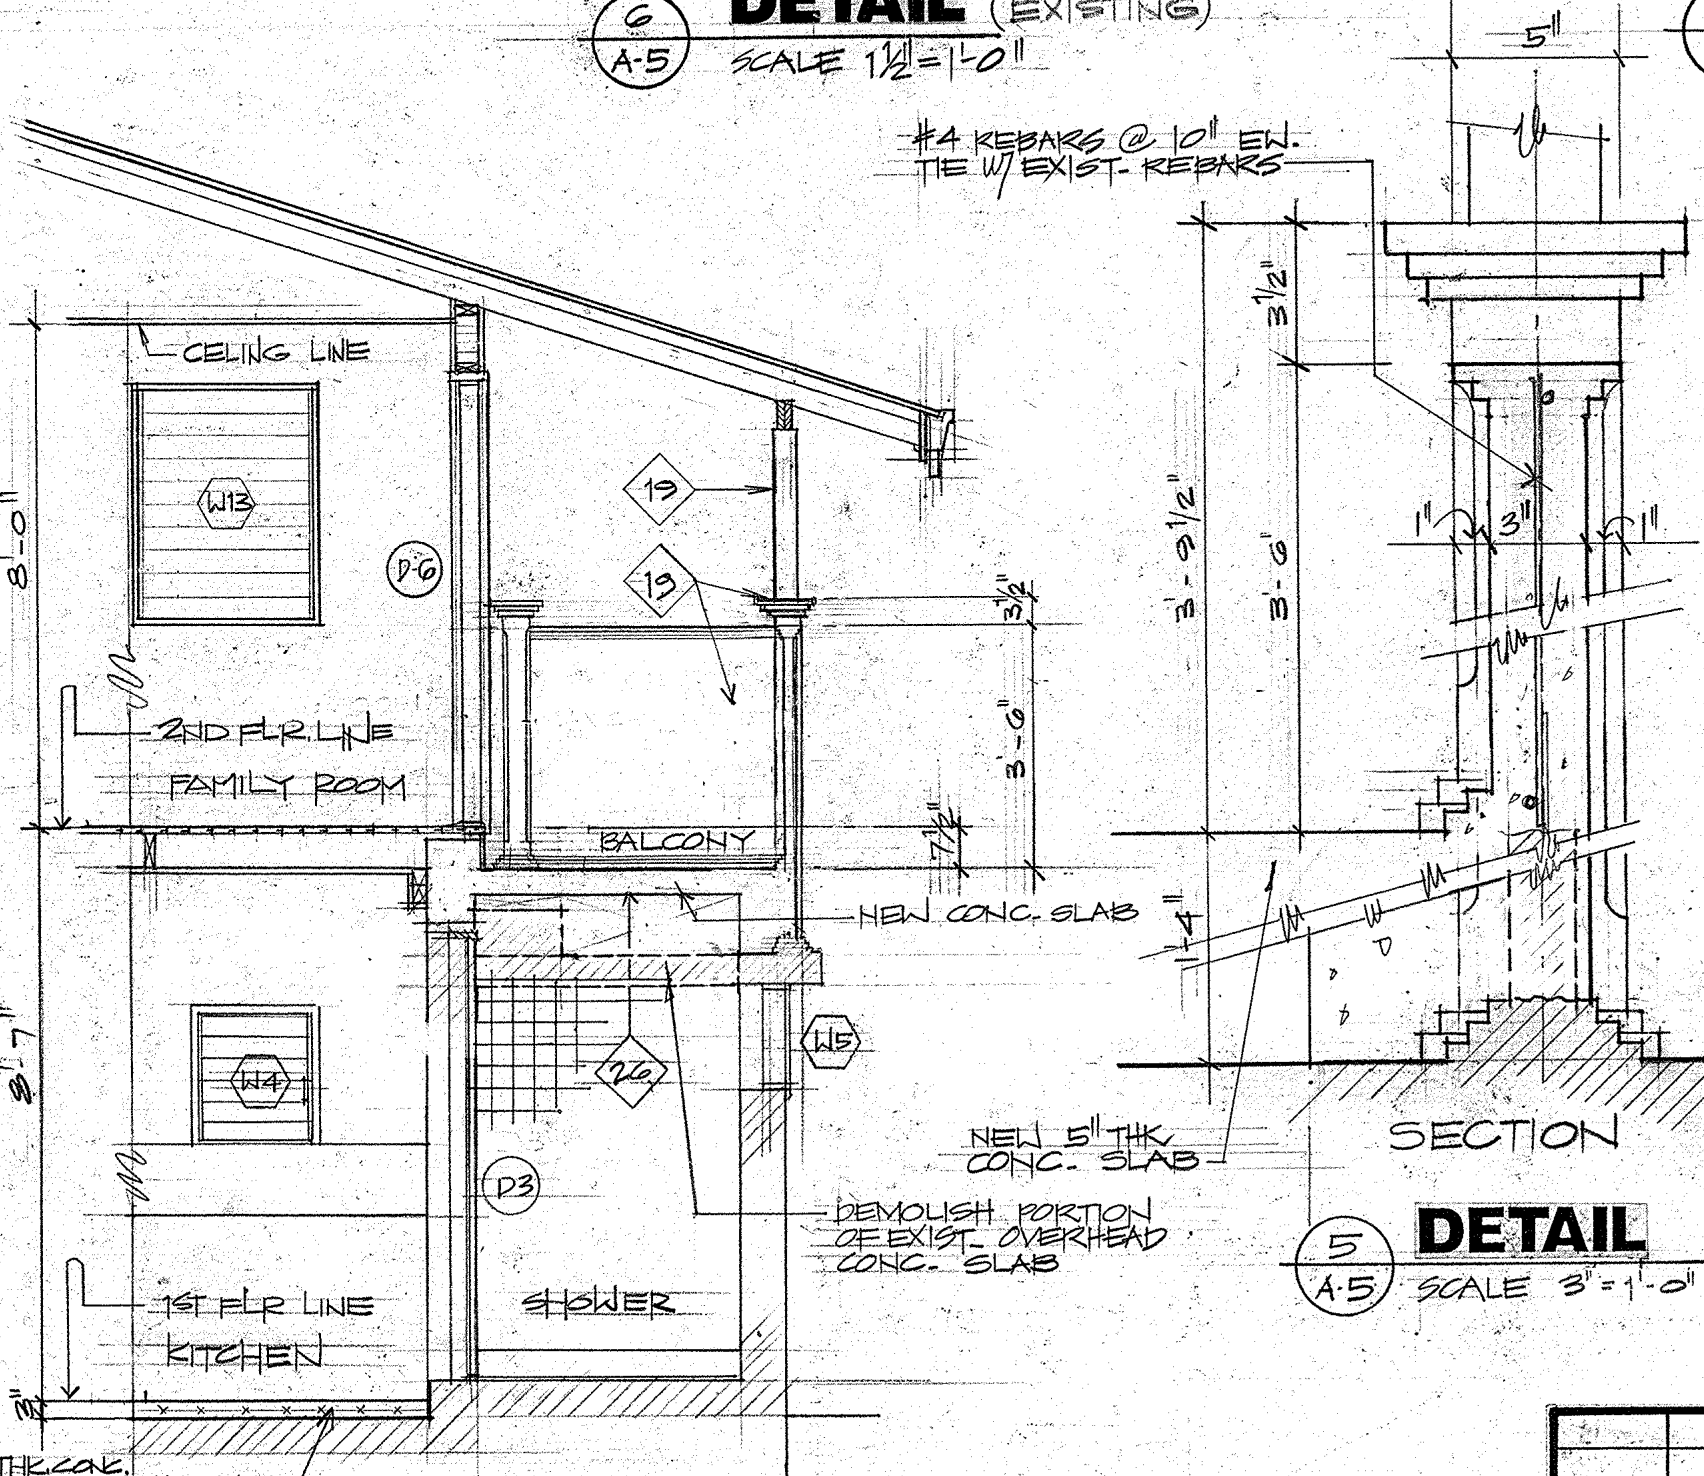


5 DETAIL

A-5 SCALE 3" = 1'-0"

4 SECTION

A-5 SCALE 1/2" = 1'-0"

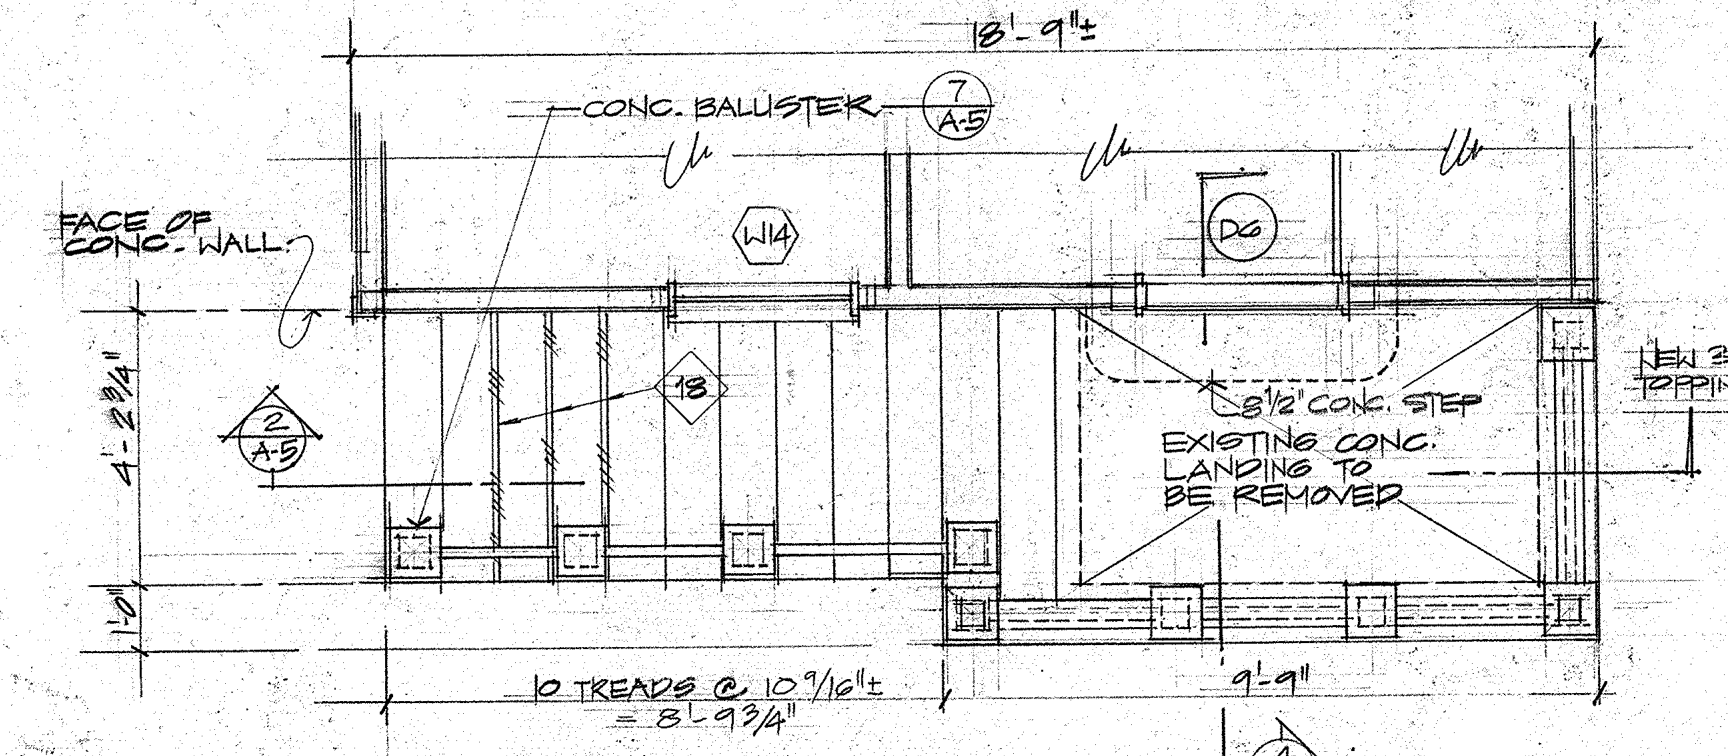


1 PLAN


A-5 SCALE 1/2" = 1'-0"

The undersigned declares hereby and acknowledges that all design and document issues shown on this page have been approved by the GPT. By signing below, the undersigned acknowledges that they understand and approve these issues.


Owner _____ Date _____
 Owner _____ Date _____

REVISION	DATE	BY	DESCRIPTION	APPROVED
PROJECT NO.				
CONTRACT NO. PTA-031				
DESIGNED BY: WAW				
DRAWN BY: ADS/WAW				
CHECKED BY: WAW				
PROJECT: RESTORATION TO THE EXISTING HISTORICAL BUILDING				INARAJAN, GUAM
MENO RESIDENCE				
LOT NO. 67				DATE:
SHEET CONTENTS: DETAIL OF CONCRETE STAIRS AND CONCRETE RAILINGS, MISCELLANEOUS DETAILS				
RECOMMENDED APPROVAL				DATE:
GUAM PRESERVATION TRUST				DATE:
willy a. watson, aia architect				DRAWER NO:
				DRAWING NUMBER A-5
				SHEET 6 OF 14

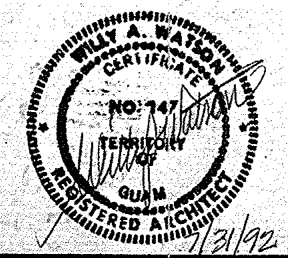


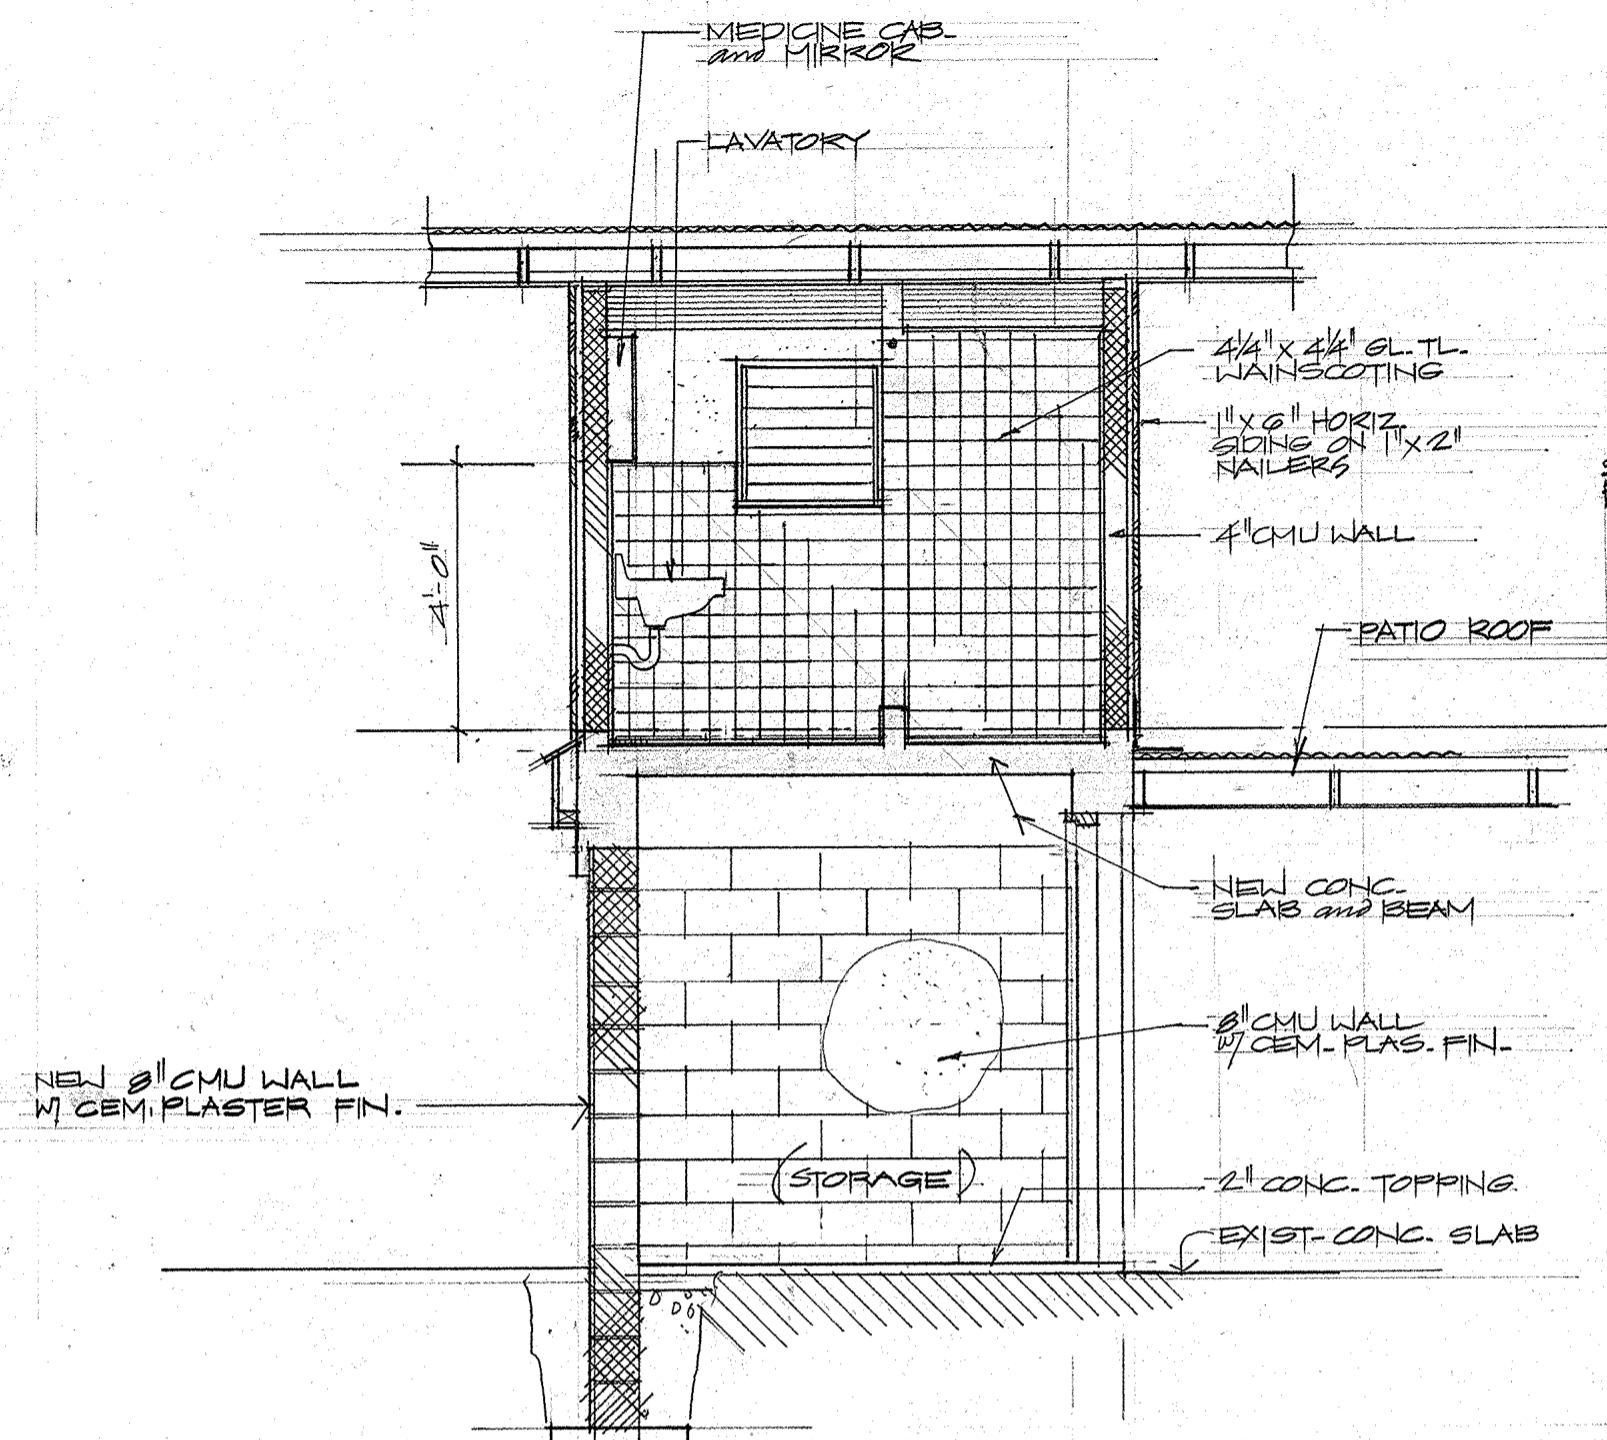

3 SECTION
A-G SCALE 1/2" = 1'-0"

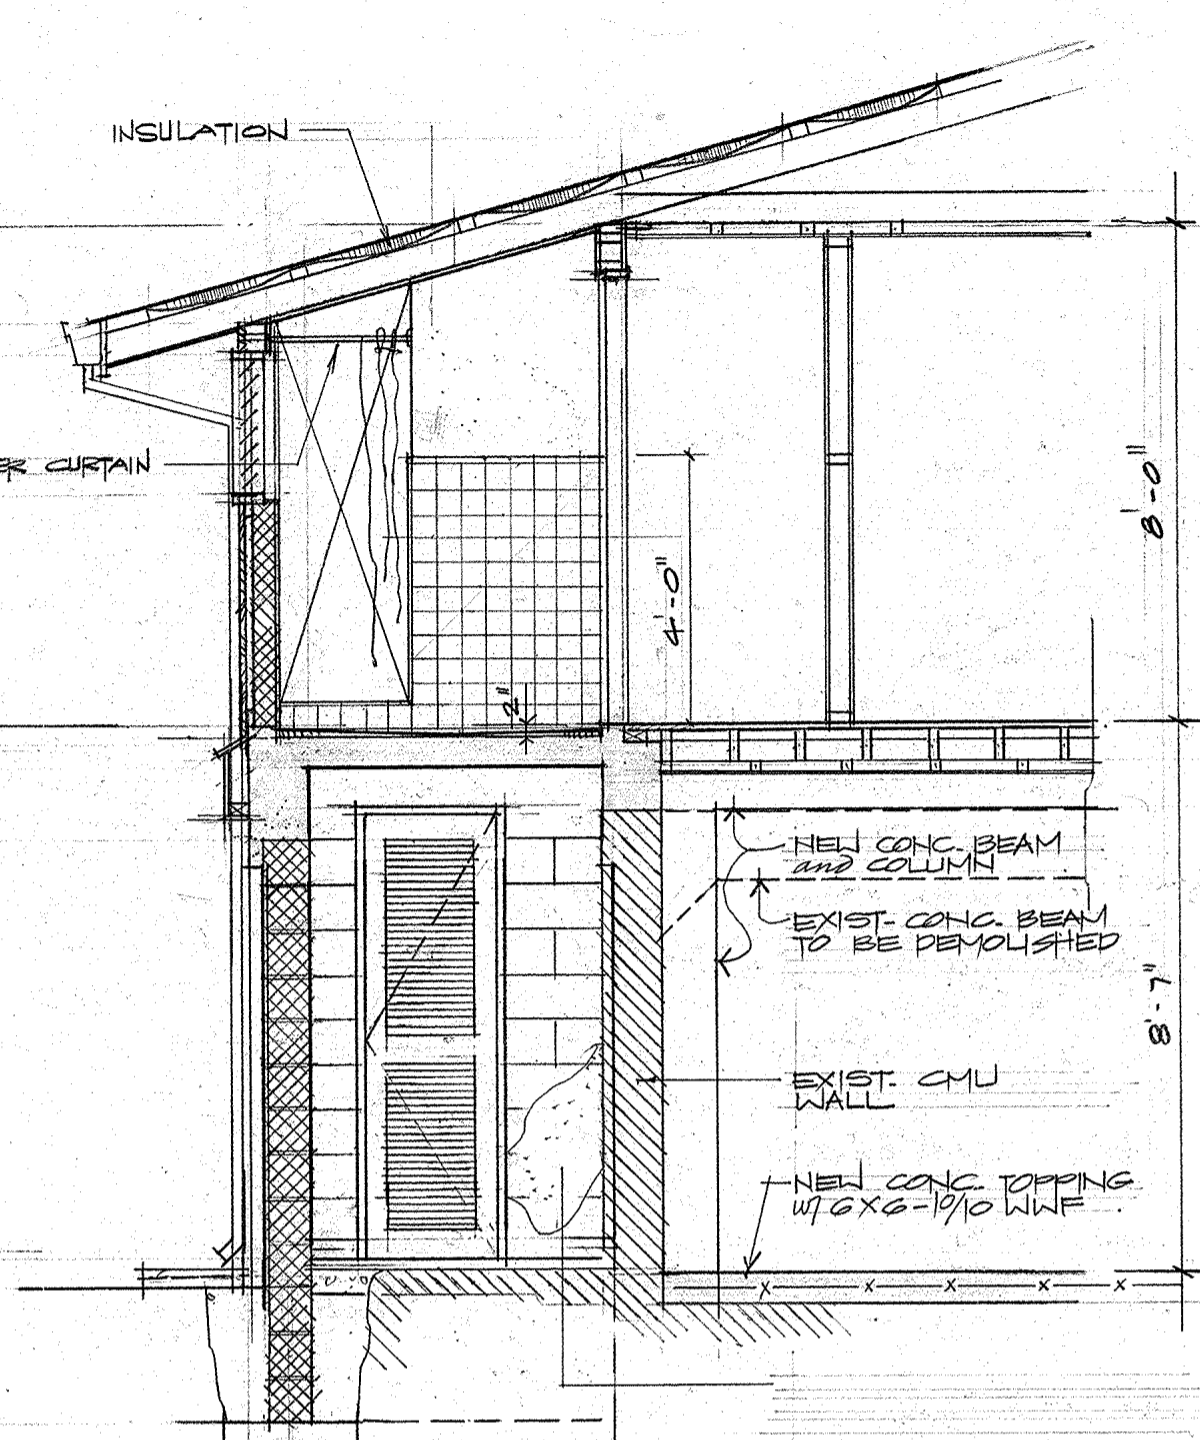


4 SECTION
A-G SCALE 1/2" = 1'-0"

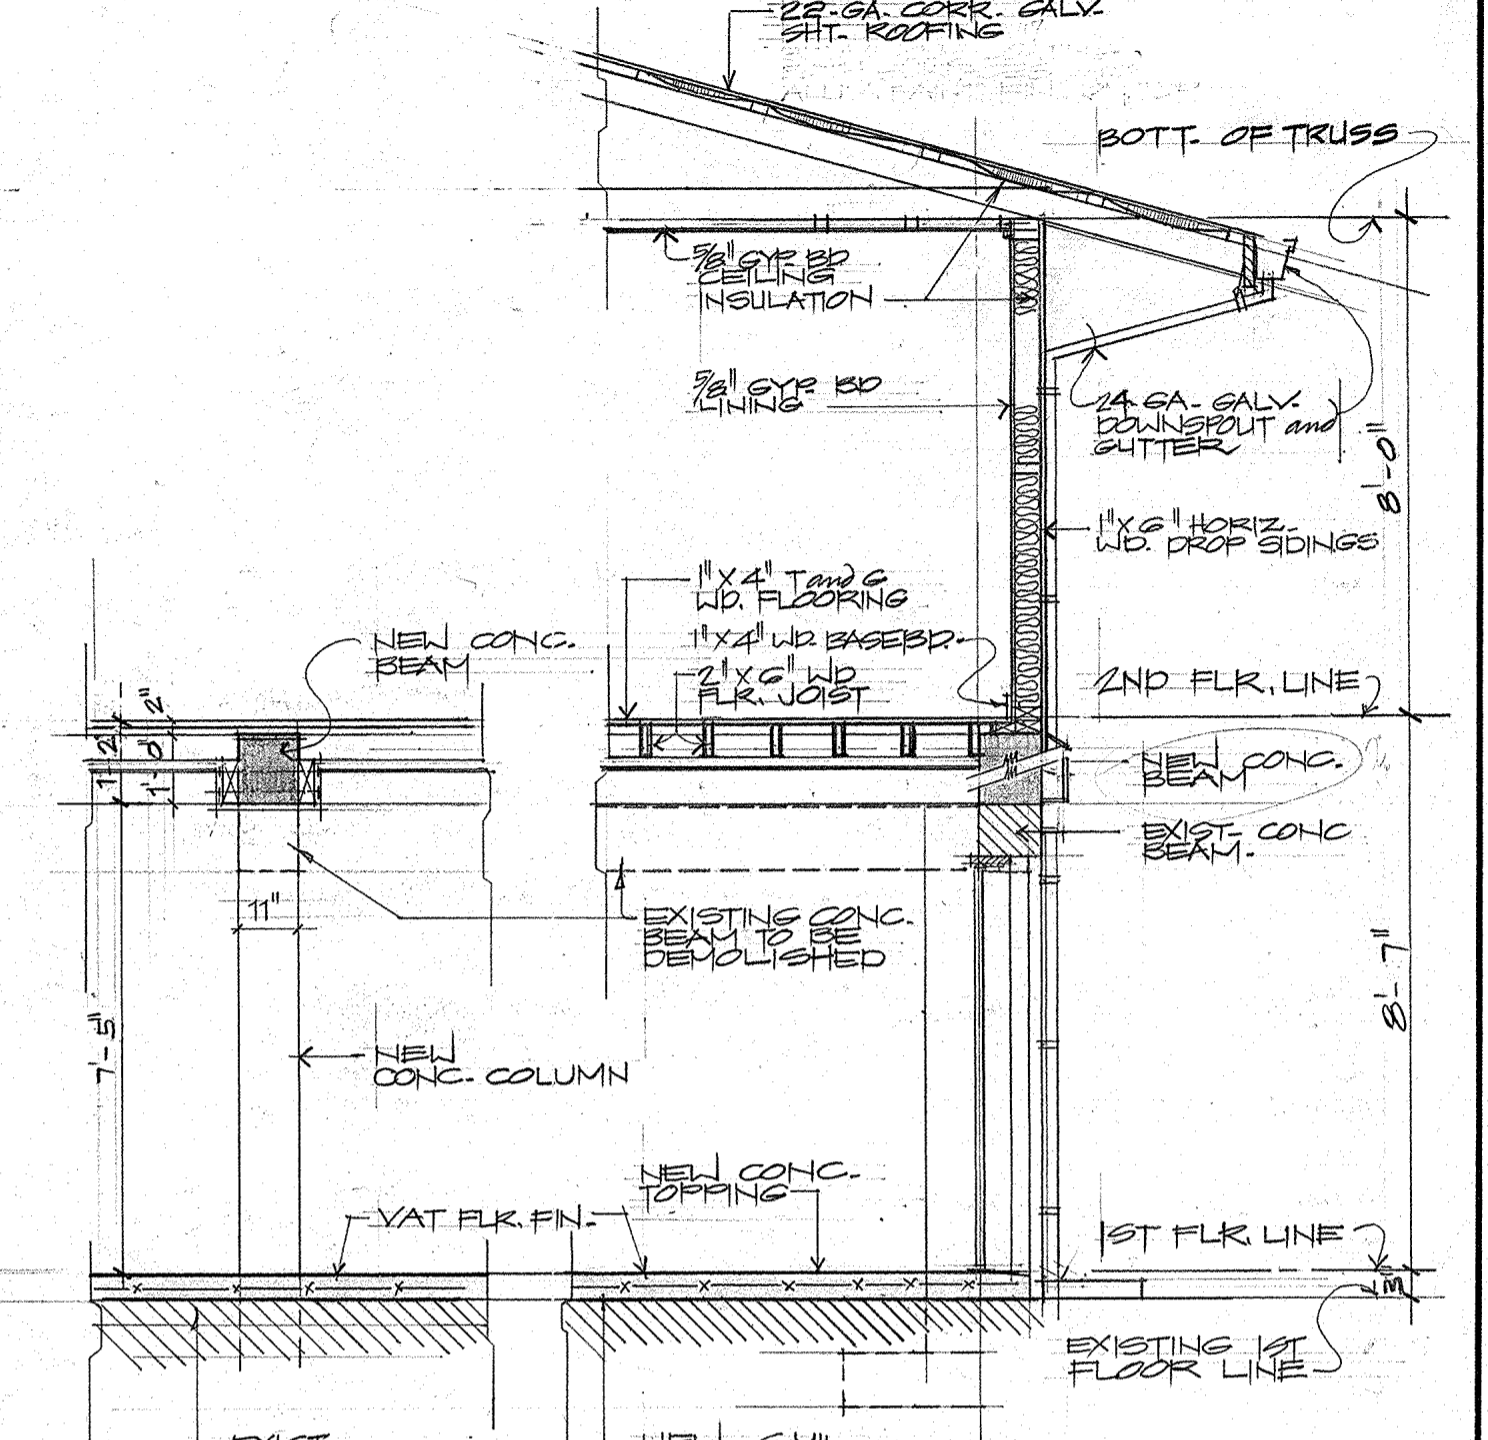


5 SECTION
A-G SCALE 1/2" = 1'-0"

6 SECTION
A-G SCALE 1/2" = 1'-0"

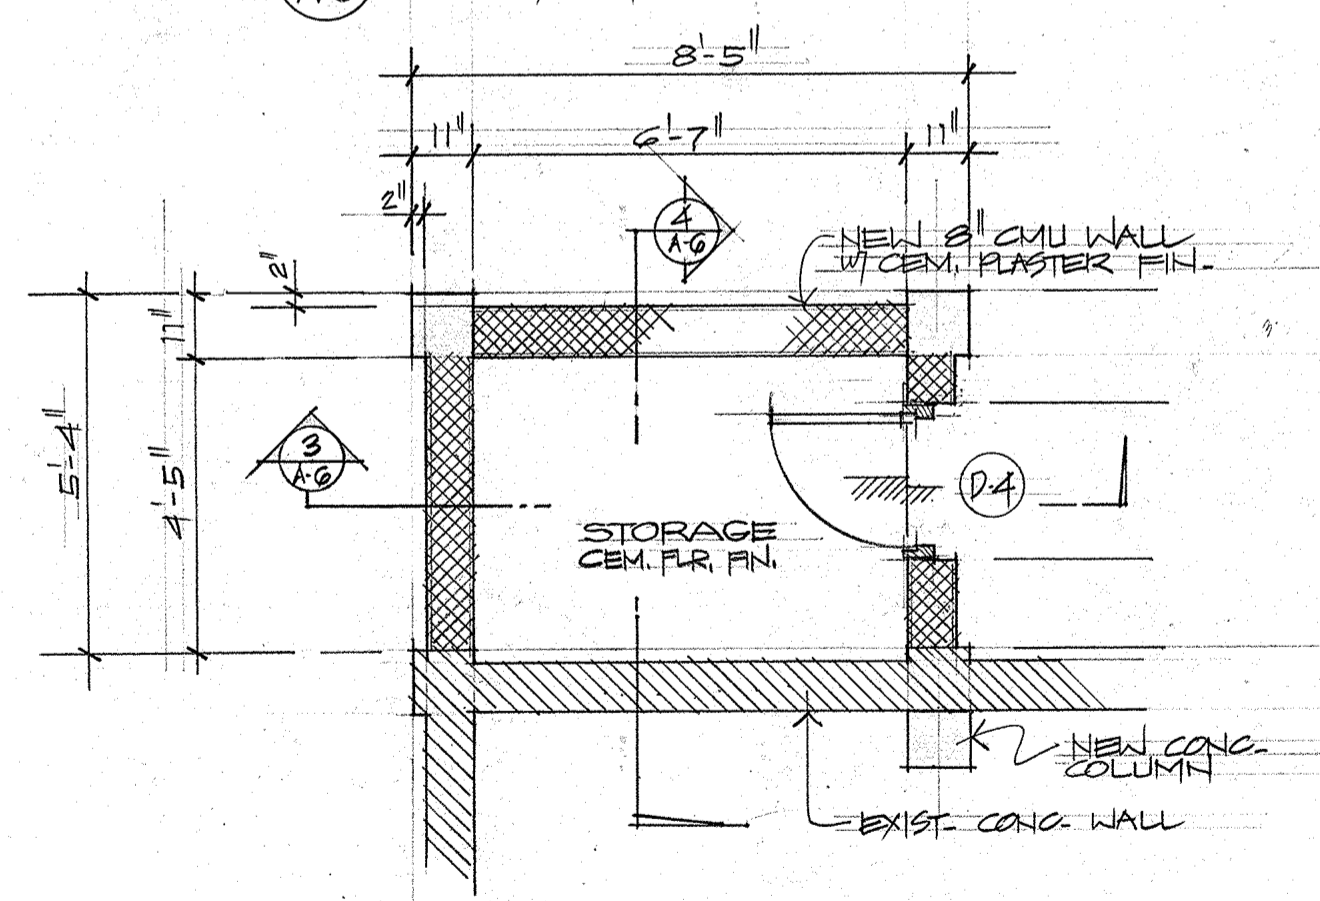

1 PLAN (FIRST FLOOR)
A-G SCALE 1/2" = 1'-0"

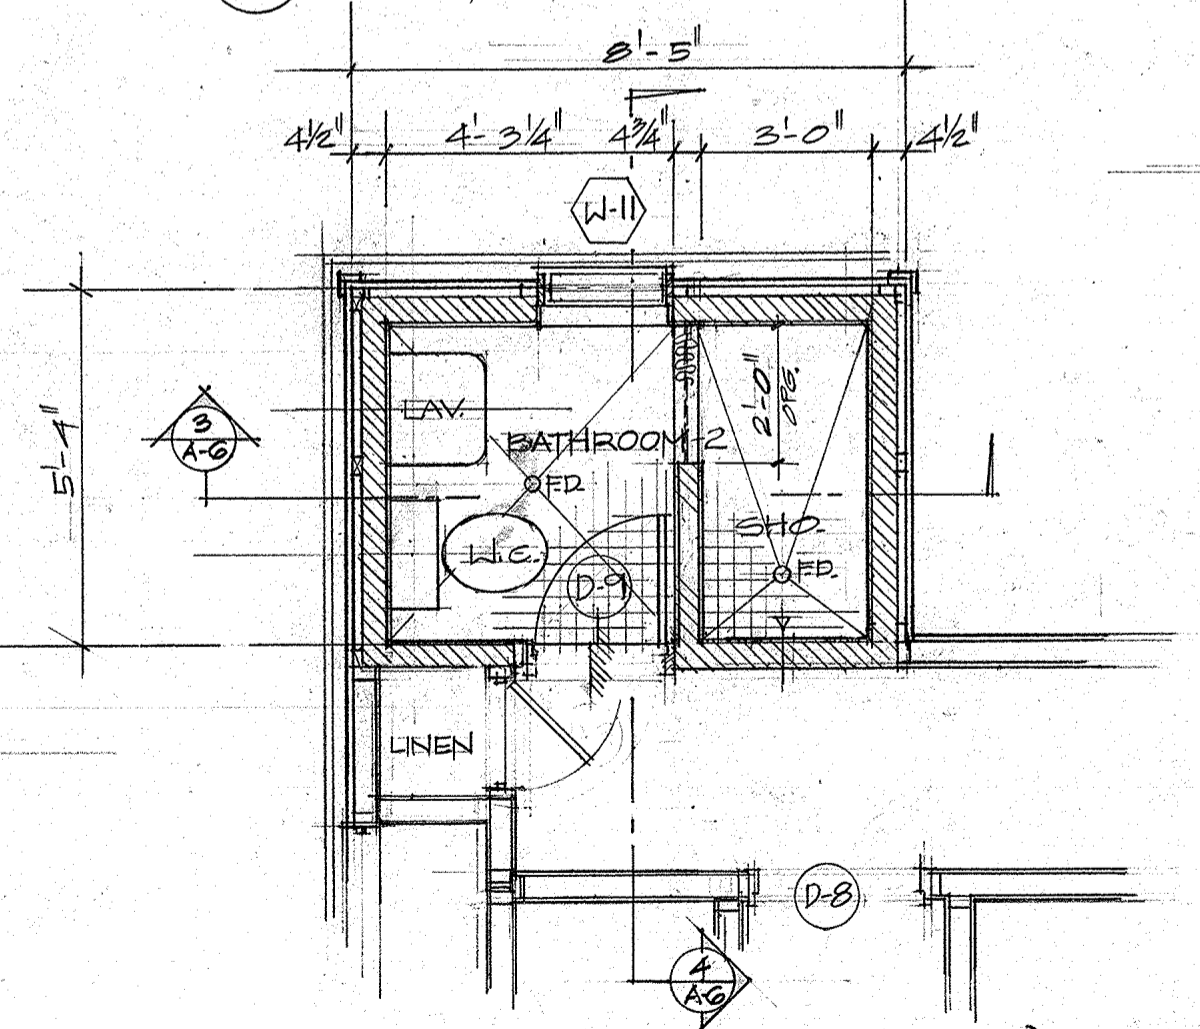


2 PLAN (SECOND FLOOR)
A-G SCALE 1/2" = 1'-0"

The undersigned hereby acknowledges that all design and payment issues shown on this page have been explained by the client. By signing below, the undersigned and approve these issues.

Owner: _____ Date: _____
Owner: _____ Date: _____

REVISION	DATE	BY	DESCRIPTION	APPROVED
PROJECT NO.				
CONTRACT NO. PTA-031				
DESIGNED BY: WAW		PROJECT: RESTORATION TO THE EXISTING HISTORICAL BUILDING		
DRAWN BY: WAW		MENO RESIDENCE		
CHECKED BY: WAW		LOT NO. 67 INARAJAN, GUAM		
SHEET CONTENTS: DETAIL PLAN, SECTIONS OF 2ND FLOOR BATHROOM, WALL SECTIONS				
RECOMMENDED APPROVAL				DATE:
GUAM PRESERVATION TRUST				DATE:
willy a. watson, aia architect				DRAWER NO:
				DRAWING NUMBER A-6
				SHEET 7 OF 14

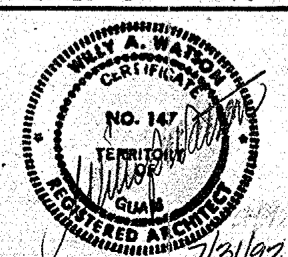

MENO

DOOR and WINDOW SCHEDULE

QTY	DOOR NO.	DOOR TYPE	DOOR				GLASS TYPE & THICKNESS	DETAILS			HARDWARE SET	REMARKS	QTY	WINDOW NO.	WINDOW TYPE	NOMINAL SIZE		DETAILS			REMARKS
			NOMINAL DIMENSION	THICKNESS	FRAME MATERIAL	CORE		FINISH	HEAD	JAMB						SILL	W	H	HEAD	JAMB	
1	(D-1)	A	3'-0" x 6'-8"	1 3/4"	WOOD	DECOR. WD. DOOR	STAIN/VARNISH	3	3	1	HW SET #1	DEMOLISH PORTION OF OH BEAM	1	(W-1)	A	3'-2" x 3'-6"	10	9	6		
1	(D-2)	B	3'-0" x 6'-8"	1 3/4"	WOOD	SOLID CORE WOOD DOOR	↓	3A	3A	2A	HW SET #1	DEMOLISH PORTION OF OH BEAM	1	(W-2)	A	3'-0" x 3'-6"	10	9	6		
1	(D-3)	C	2'-0" x 6'-8"	1 3/8"	WOOD	HOLLOW CORE WD. DOOR	↓	5	5	○	HW SET #4	NO ALUMINUM THRESHOLD	1	(W-3)	A	3'-0" x 3'-6"	10	9	6		
1	(D-4)	D	2'-0" x 6'-8"	1 3/8"	WOOD	↓	PAINT	5	5	○	HW SET #2	↓	1	(W-4)	A	3'-0" x 2'-0"	10	9	6		
1	(D-5)		2'-0" x (VARIES FR 2'-5" TO 4'-3")	1 1/2"	WOOD	DBLE 3/4" THK PLYWOOD	PAINT	5	5	○	HW SET #2	2-3/4" THK MARINE PLYWOOD	1	(W-5)	A	2'-6" x 1'-6"	10	9	6		
1	(D-6)	A	3'-0" x 6'-8"	1 3/4"	WOOD	DECOR. WIP. DOOR	STAIN/VARNISH	4	4	2	HW SET #1	NO ALUMINUM THRESHOLD	1	(W-6)	A	2'-8" x 3'-6"	11	9	8		
1	(D-7)	C	2'-6" x 6'-8"	1 3/8"	WOOD	HOLLOW CORE WD. DOOR	↓	5	5	○	HW SET #4	↓	2	(W-7)	A	2'-0" x 3'-6"	11	9	8		
1	(D-8)	C	2'-6" x 6'-8"	1 3/8"	WOOD	↓	↓	5	5	○	↓	↓	1	(W-8)	A	2'-8" x 3'-6"	11	9	8		
1	(D-9)	C	2'-0" x 6'-8"	1 3/8"	WOOD	↓	↓	5	5	○	↓	↓	1	(W-9)	A	2'-8" x 3'-6"	11	9	8		
													1	(W-10)	A	2'-8" x 3'-6"	11	9	8		
													1	(W-11)	A	2'-0" x 2'-0"	11	9	8	4" WALL W/ 1" x 6" HOR. SIDING	
													1	(W-12)	A	2'-8" x 3'-6"	11	9	8		
													1	(W-13)	A	2'-8" x 3'-6"	11	9	8		
													1	(W-14)	A	2'-8" x 3'-6"	11	9	8		

DOOR and WINDOW TYPES

A
3/4" THK DECORATIVE WOOD PANEL DOOR

B
FLUSH TYPE SOLID CORE WOOD DOOR

C
FLUSH TYPE HOLLOW CORE WOOD DOOR

D
3/8" THK. WOOD LOUVER DOOR

A
1/4" x 4" W. OBSCURED GLASS LOUVERS and ALUM. FRAME & OPERATOR

(A-7) JAMB
SCALE 3/8" = 1'-0"

(A-7) HEAD
SCALE 3/8" = 1'-0"

(A-7) HEAD
SCALE 3/8" = 1'-0"

(A-7) SILL
SCALE 3/8" = 1'-0"

(A-7) SILL
SCALE 3/8" = 1'-0"

(A-7) HEAD/JAMB
SCALE 3/8" = 1'-0"

(A-7) HEAD/JAMB
SCALE 3/8" = 1'-0"


(A-7) HEAD/JAMB
SCALE 3/8" = 1'-0"

(A-7) SILL
SCALE 3/8" = 1'-0"

(A-7) SILL
SCALE 3/8" = 1'-0"

(A-7) HEAD/JAMB
SCALE 3/8" = 1'-0"

REVISION	DATE	BY	DESCRIPTION	APPROVED
PROJECT NO. _____				
CONTRACT NO. PTA-031				
GUAM PRESERVATION TRUST				
PROJECT: RESTORATION TO THE EXISTING HISTORICAL BUILDING				
MENO RESIDENCE LOT NO. 67 INARAJAN, GUAM				
DESIGNED BY: WAW				
DRAWN BY: ABS/KW				
CHECKED BY: WAW				
RECOMMENDED APPROVAL DATE: _____				
GUAM PRESERVATION TRUST DATE: _____				
willy a. watson, aia architect				
DRAWER NO: _____				
DRAWING NUMBER A-7				
SHEET 2 OF 14				

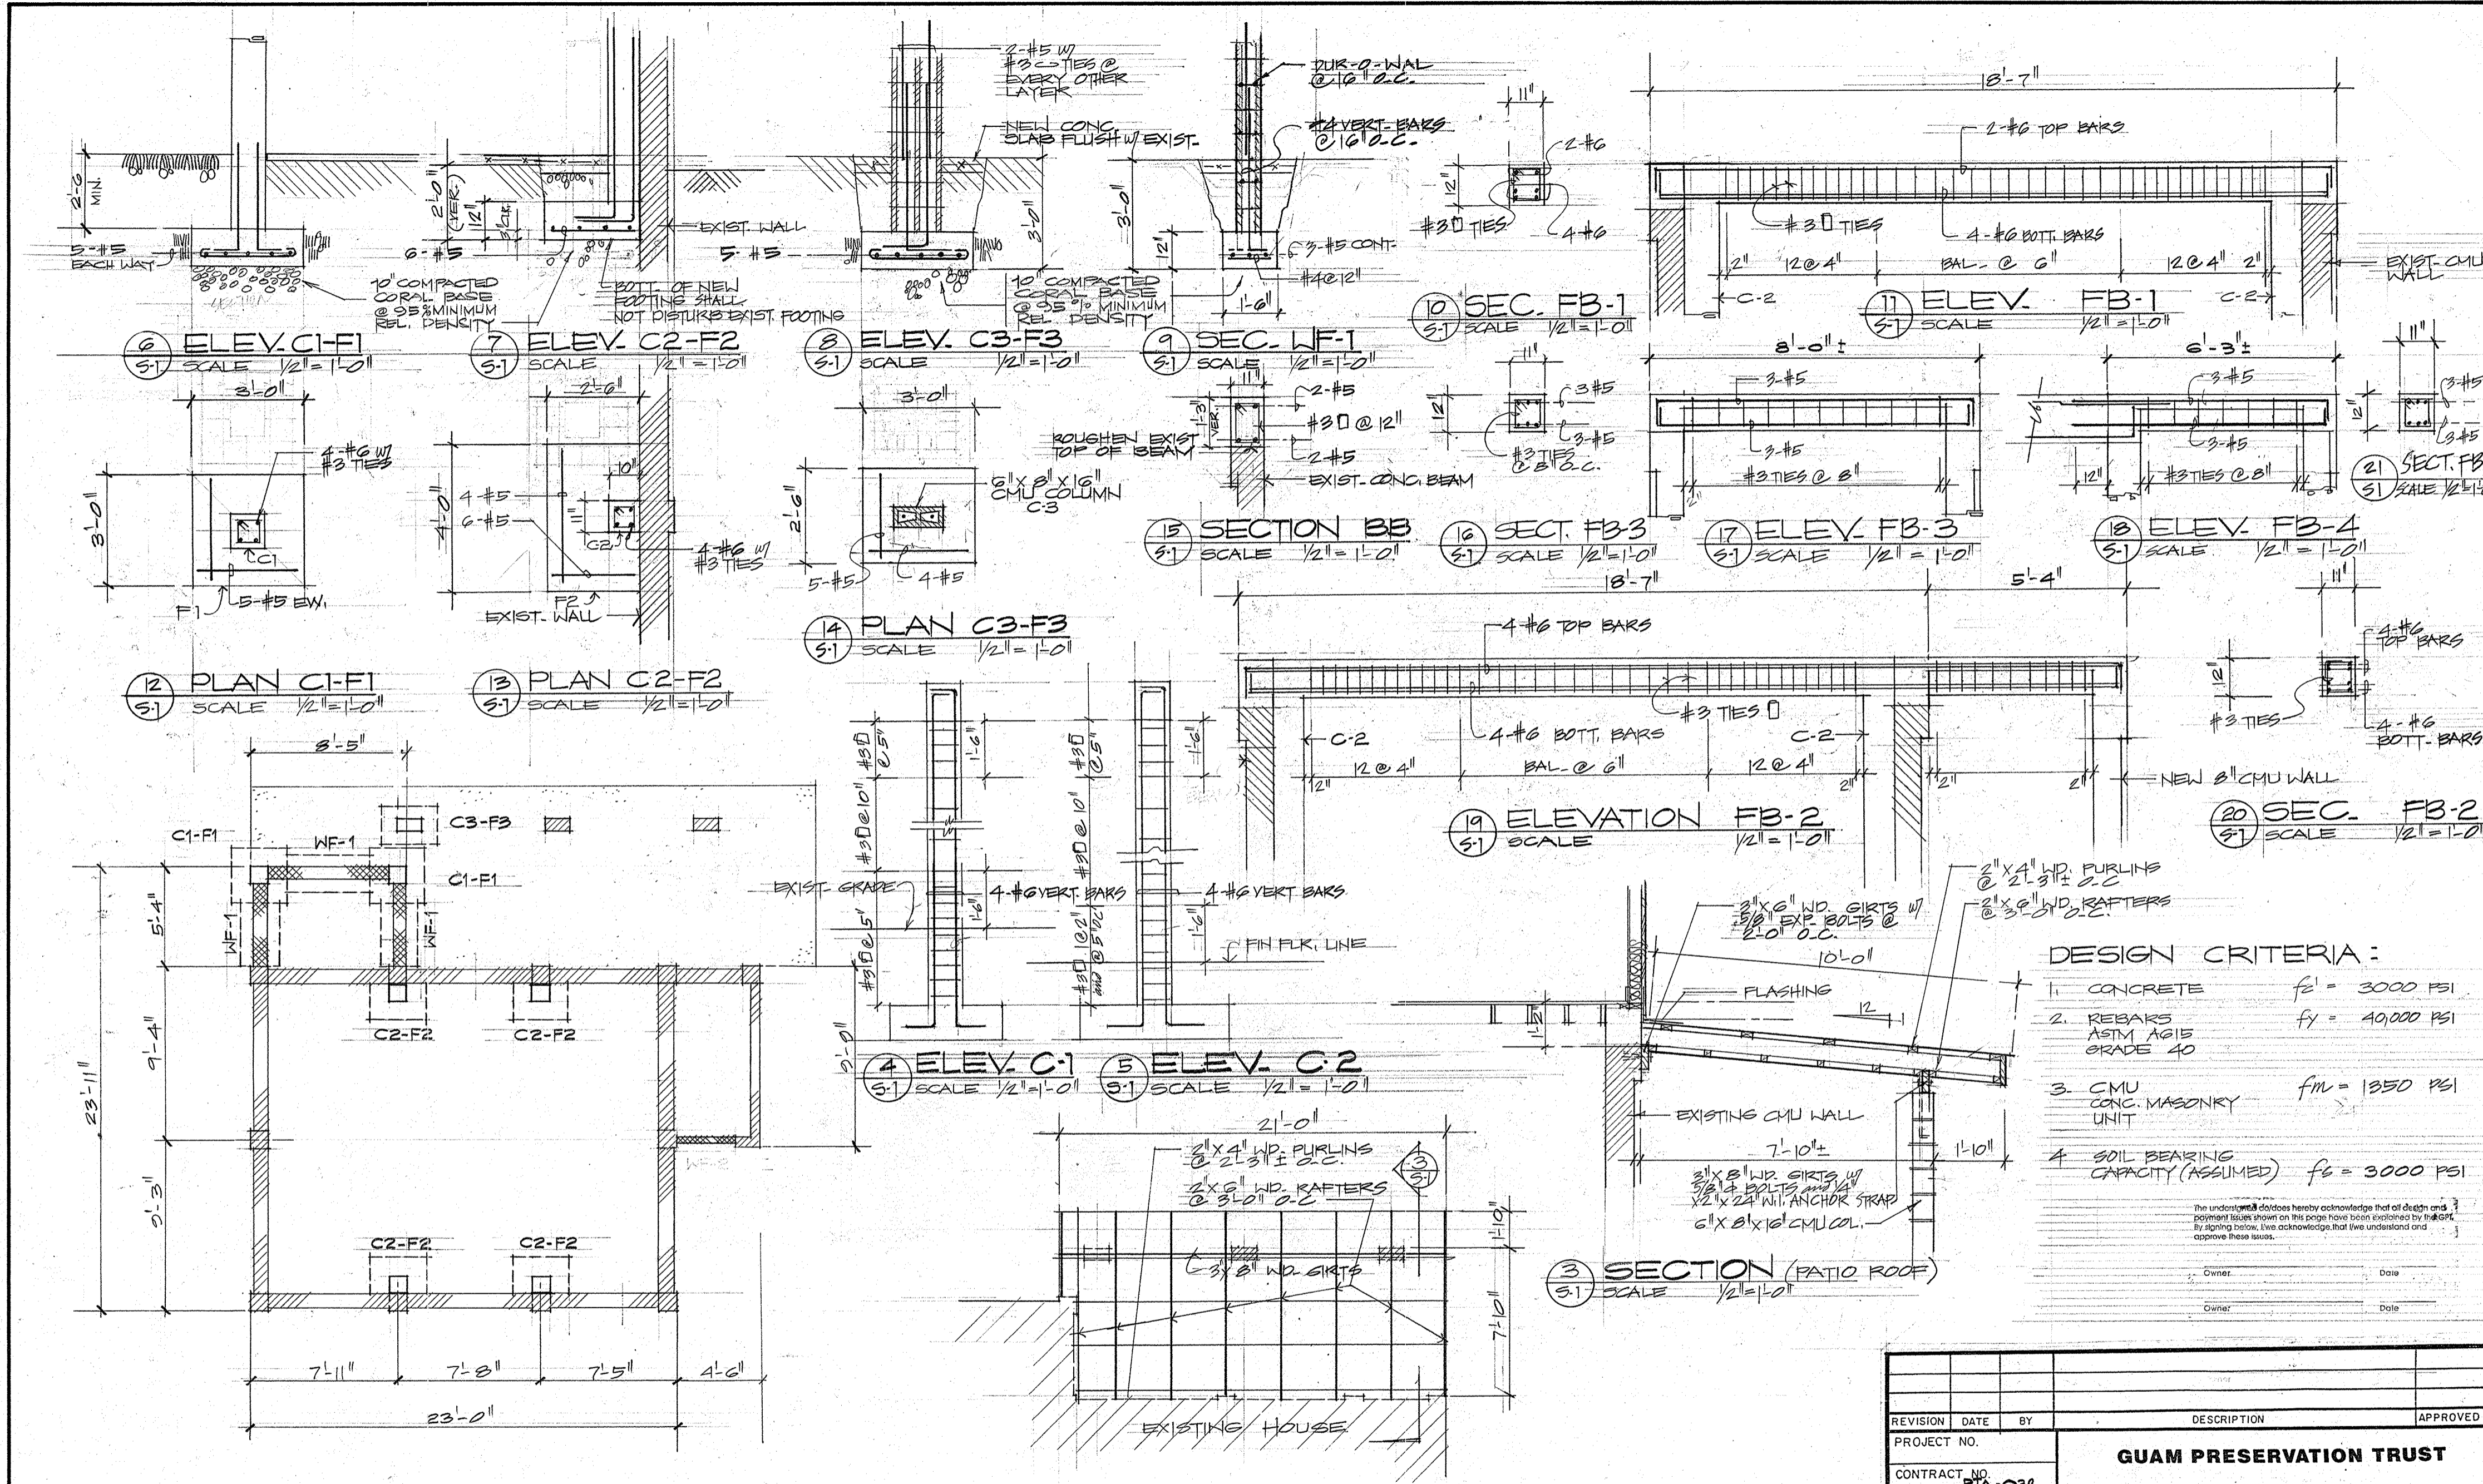


- DESIGN CRITERIA:**
- CONCRETE $f'_c = 3000$ PSI
 - REBARs ASTM A615 GRADE 40 $f_y = 40,000$ PSI
 - CMU CONC. MASONRY UNIT $f_m = 1350$ PSI
 - SOIL BEARING CAPACITY (ASSUMED) $f_s = 3000$ PSI
- The undersigned does hereby acknowledge that all design and payment issues shown on this page have been explained by the GPT. By signing below, I/we acknowledge that I/we understand and approve these issues.
- Owner: _____ Date: _____
 Contractor: _____ Date: _____


REVISION	DATE	BY	DESCRIPTION	APPROVED
PROJECT NO.				
CONTRACT NO. PIA-032				
DESIGNED BY: MSS				
DRAWN BY: NA				
CHECKED BY: MSS				
RECOMMENDED APPROVAL				DATE:
GUAM PRESERVATION TRUST				DATE:
willy a. watson, aia architect				DRAWER NO:
				DRAWING NUMBER 5-1
				SHEET 0 OF 14

LEGEND AND ABBREVIATION

SYMBOL	ABBR.	DESCRIPTION
	SORW	SOIL OR WASTE LINE
	V	VENT LINE
	CW	COLD WATER LINE
	HW	HOT WATER LINE
	FCO	FLOOR CLEANOUT
	FD	FLOOR DRAIN
	GCO	GROUND CLEANOUT
	HB	HOSE BIBB
	LAV	LAVATORY
	POC	POINT OF CONNECTION
	EWH	ELECTRIC WATER HEATER
	WC	WATER CLOSET

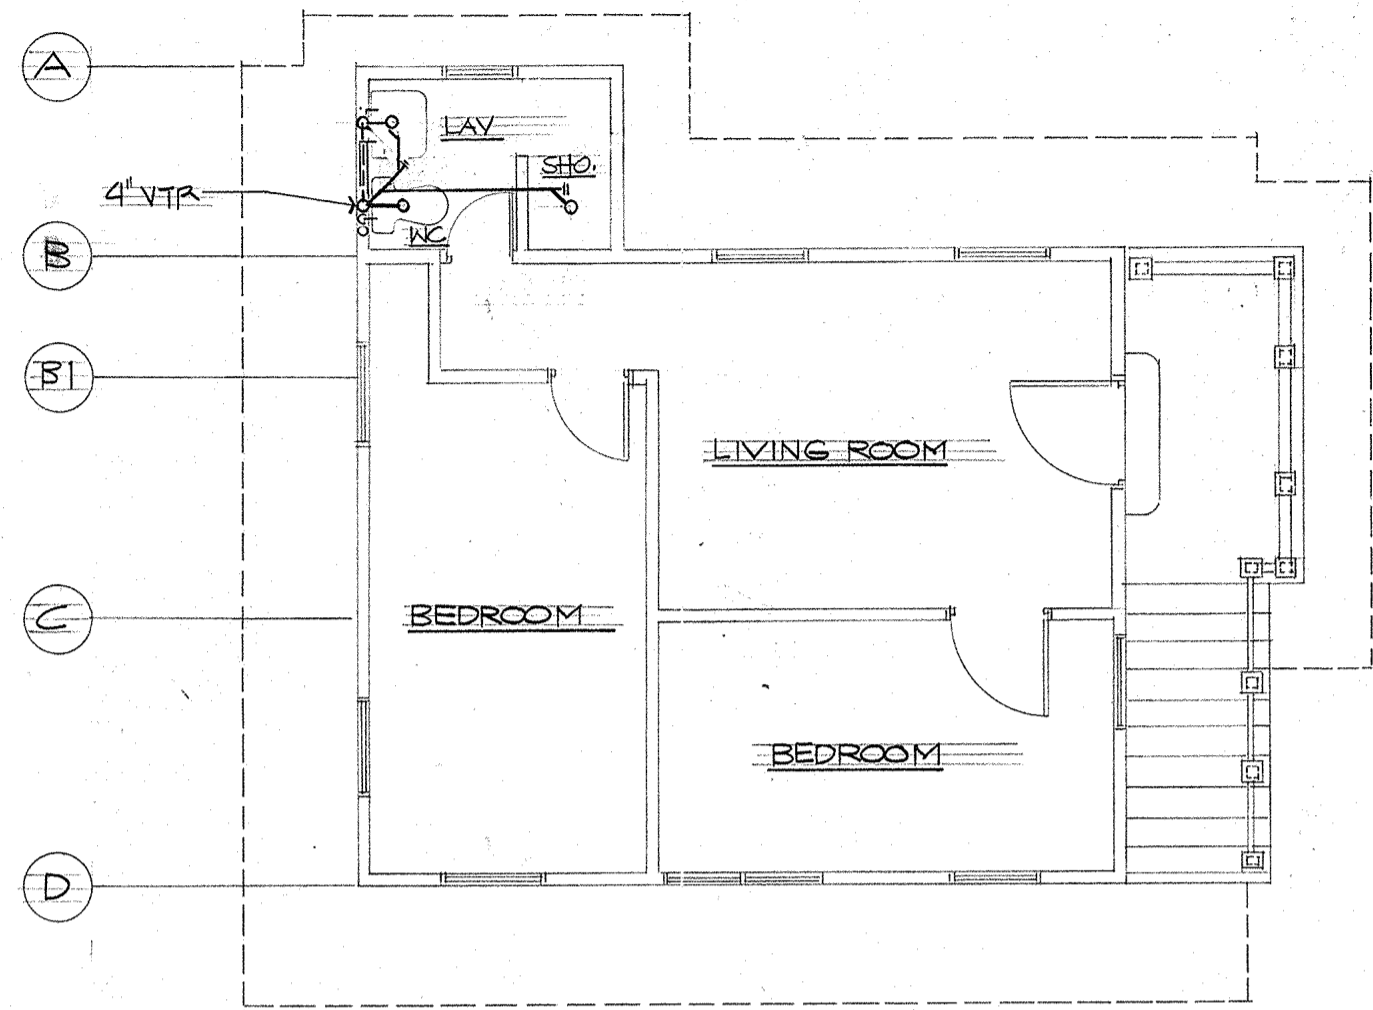

2 NEW PLUMBING PLAN-2ND FLOOR
SCALE: 1/4"=1'-0"

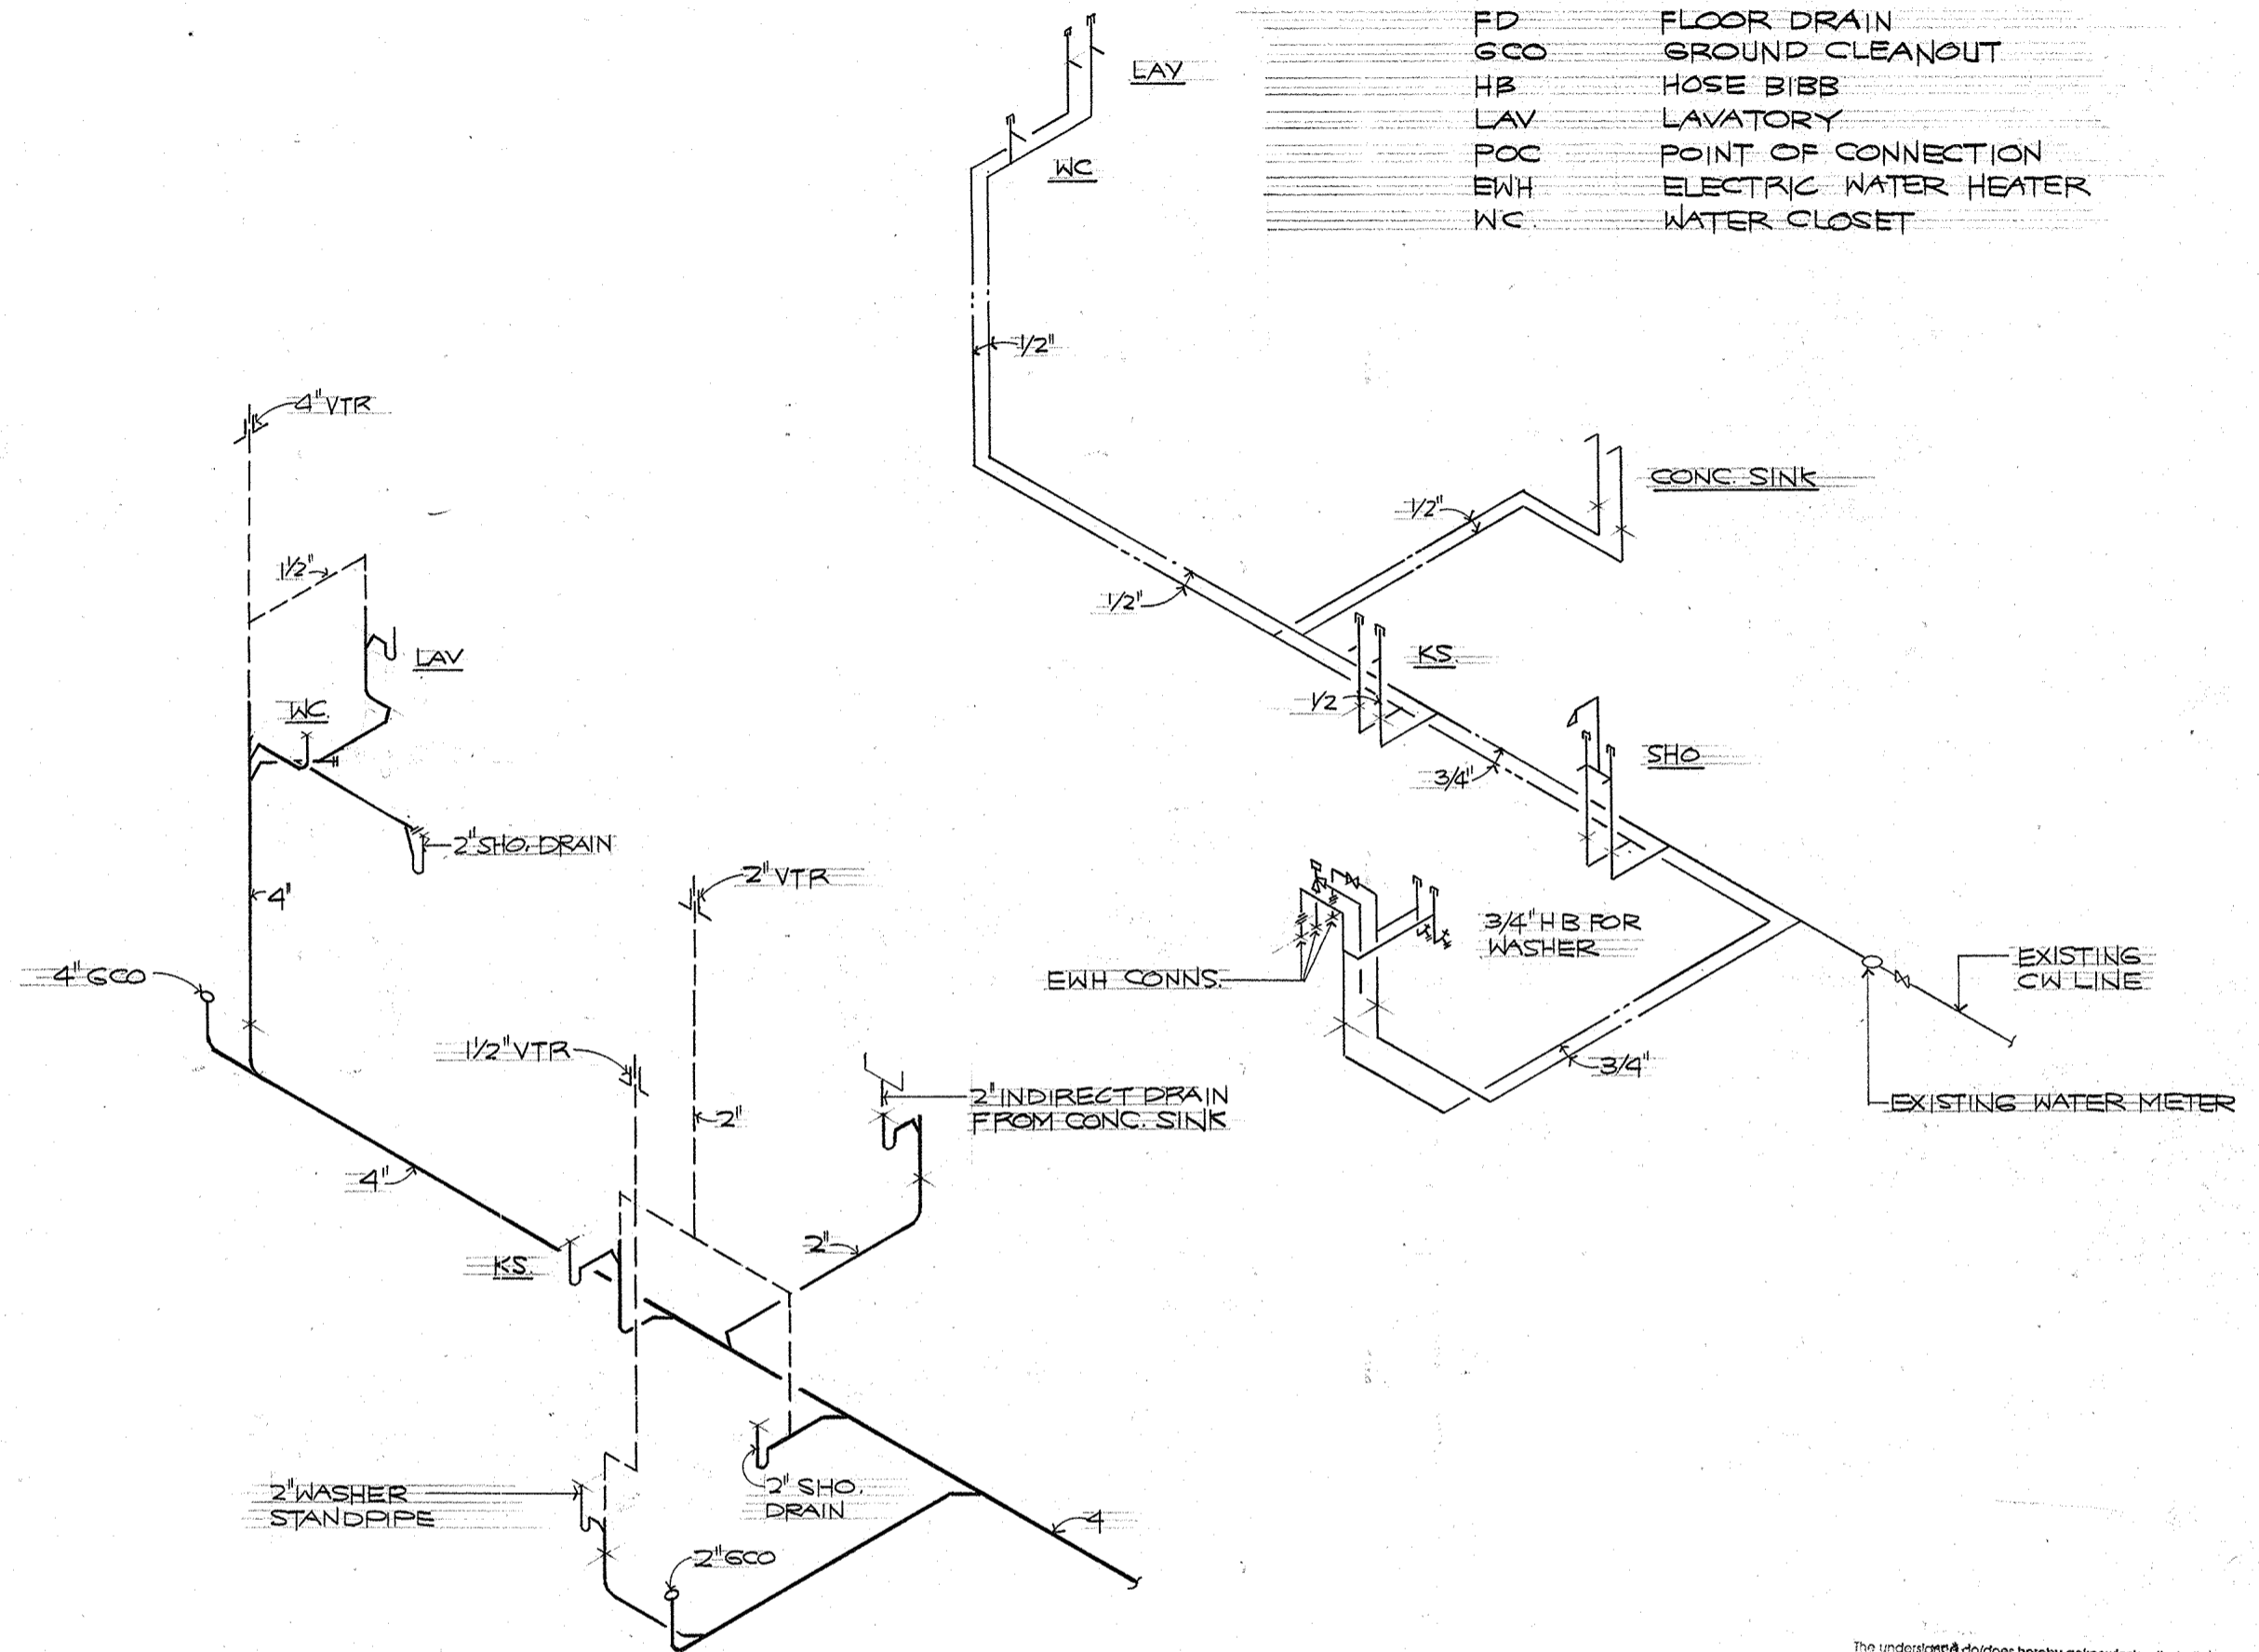


3 S, W, V, CW & HW PIPING ISOMETRIC
SCALE: NOT TO SCALE

The undersigned does hereby acknowledge that all design and payment issues shown on this page have been explained by the architect and approved by the owner.


Owner: _____ Date: _____

Owner: _____ Date: _____

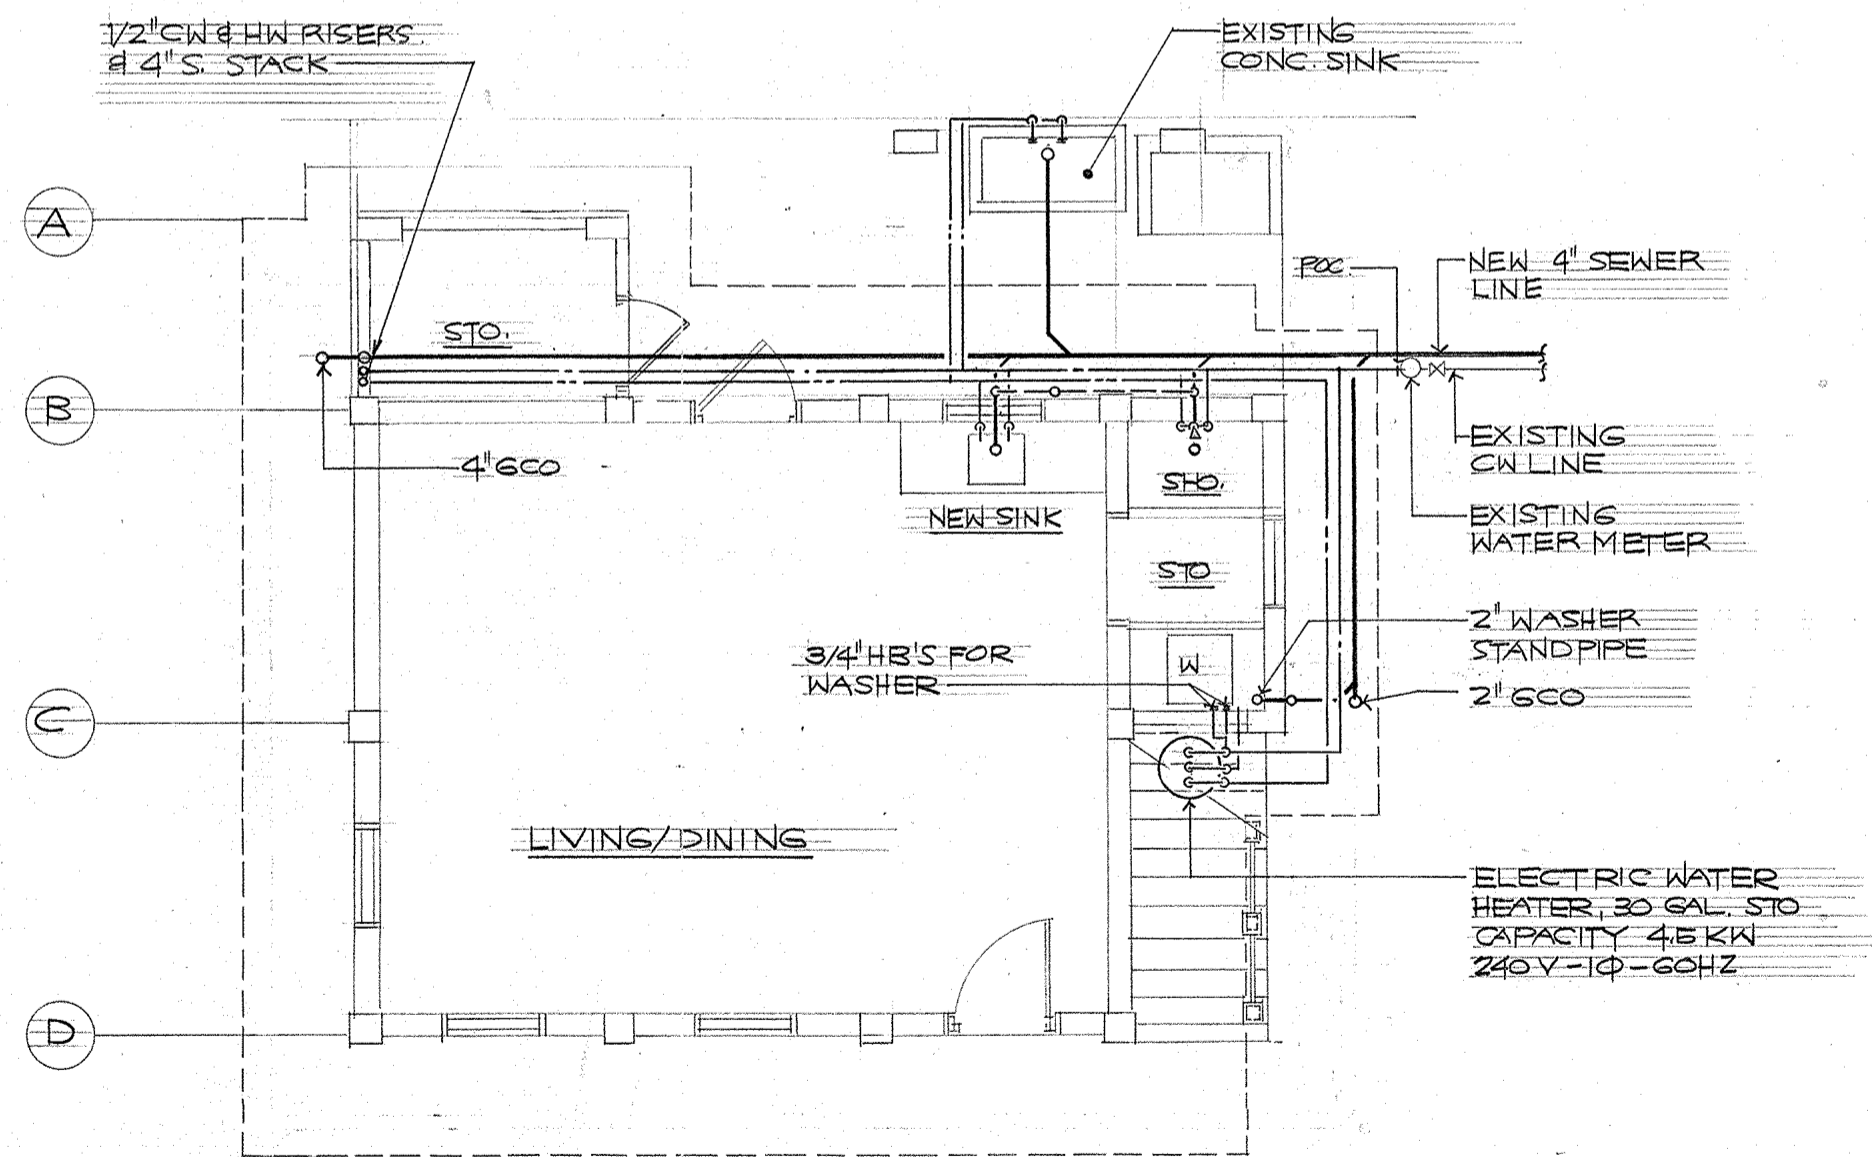

1 NEW PLUMBING PLAN-1ST FLOOR-MENO HOUSE
SCALE: 1/4"=1'-0"

ELECTRIC WATER HEATER, 30 GAL. STO. CAPACITY 45 KW 240V-1Ø-60HZ

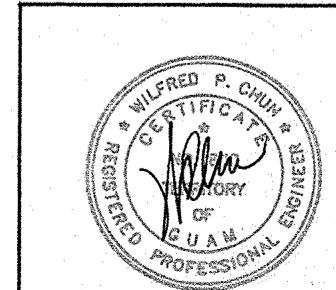

I HEREBY CERTIFY THAT THIS PLAN WAS PREPARED BY ME OR UNDER MY DIRECT SUPERVISION.

REVISION	DATE	BY	DESCRIPTION	APPROVED
PROJECT NO.				
CONTRACT NO. PTA-033				
DESIGNED BY: SU			SHEET CONTENT	
DRAWN BY: SU			NEW PLUMBING PLAN-FIRST & SECOND FLOOR	
CHECKED BY: WC			S, W, V, CW & HW PIPING ISOMETRIC AND	
SUPV. BY: WC			LEGEND & ABBREVIATION	
RECOMMENDED APPROVAL				DATE:
GUAM PRESERVATION TRUST				DATE:
willy a. watson, aia architect			DRAWER NO:	
			DRAWING NUMBER	P-1
			SHEET	12 OF 14

